

SHEET NO.	
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		IS	SUE: ISSU	JE: RE-ISSUE:	ISSUE:	RE-ISSUE:				
T	SHEET NAME	RE	VIEW PERM -08-12 2022-0	IITS PERMITS	REVIEW 2022-12-29	BOARD	ISSUE ISSUE	ISSUE	66 GAYWOOD AVENUE COLONIA, NJ 07067	
ITECTU									908-418-2148 MIKEATING1128@ICLOUD.COM	
1 GENE	E SHEET ERAL NOTES & DETAILS		• • • •	•	•	•			Seal & Signature:	
1 DEMO	PLAN, ZONING INFO. & PLUMBING RISER DIAGRAM DLITION PLAN - FIRST FLOOR		• •		•	•			MICHAEL P. KEATINTG, AIA, NCARB NEW JERSEY: 21AI02176600	
2 CONS	STRUCTION PLAN - BASEMENT & FIRST FLOOR STRUCTION PLAN - SECOND FLOOR & ATTIC		• •	•	•	•				
2 ROOI	MING PLANS & DETAILS - ALL FLOORS F PLAN & FRAMING DETAILS		· ·	•	•	•				
1 BUIL	ING & POWER PLANS - ALL FLOORS DING ELEVATIONS DING SECTIONS		• • • •		•	•				
. NUMBE	ER OF SHEETS: 11	I							Typical Graphics Legend:	
NER INFO	RMATION:			SCOPE OF	WORK.				SECTION SURFACE	
IE:		FRANK L	TTERIO	DEMOLITIO						
NE:		908-499-4	1400			NG ROOF AND	ATTIC STRUCTURE.		ELEVATION/SECTION/DE1	
IL:		FLITTERI	O@MSN.COM	• REMO	VE EXISTING E	ENCLOSED FRO	NT PORCH FLOOR STRUCTU	RE.	ELEVATION OR SECTION	
				_		STAIRS TO BAS	EMENT AND ATTIC.		NEW DOOR SWING	
JECT DA	<u>TA:</u>						ALLS AS NOTED.		COUNTERTOP/MILLWORK	٢ĸ
USE GR		R-5		• REMO	VE EXISTING E	BACK DECK, ST	AIRS & CELLAR DOOR TO BA	SEMENT.	AREA NOT IN CONTRACT	т
CONSTR	RUCTION TYPE	V-B		NEW WORK	::					F 0111
CLIMAT		4A				-	OF STRUCTURE AS NOTED.		EXISTING TO BE DEMOLIS	
	G GROUND COVERAGE G FLOOR AREA:	1,281 1,281	SQ. FT. SQ. FT.		-	RST FLOOR ANI	D SECOND FLOOR LAYOUT.		DM RR EX EXISTING TO REMAIN EXISTING TO BE REMOVE	
AREA O	F WORK:						N. I FRONT ENTRY.		Project/Client:	
<u>SE</u>	RST FLOOR <u>ECOND FLOOR</u> DTAL	1,186 <u>1,243</u> 2,429	SQ. FT. <u>SQ. FT.</u> SQ. FT.	• INSTA	ALL NEW WIND	OWS THROUGH	IOUT.			
	DIAL DN GROUND COVERAGE	2,429 N/A	J. F.I.			ELECTRICAL TH			HOUSE RENOVATION	١S
	ADDITION FLOOR AREA:	1,243	SQ. FT.			PORCH & STAIR	S.			
ADDITIC	DN VOLUME:	9,944	CU. FT.	• NEW	BACK DECK RA	AILING.			Project Location:	
										E
RIVIATION	<u>IS:</u>								CRANFORD, NEW JERS	
#		F FA			I	P PL			BLOCK: 235 LOT: 14	4
∝ < @	AND ANGLE AT	FD FE EG	FLOOR DRA FIRE EXTINO	GUISHER		PLYWD PNL PR	PLYWOOD PANEL PAIR			
е ¢ Я	AT CENTERLINE DIAMETER OR ROUND	FG FIN FLR	FIBERGLAS FINISH FLOOR	U		PR PSF PSI	PAIR POUND PER SQUARE FOO POUND PER SQUARE INCH			
0 ACT	ACOUSTICAL CEILING TILE	FLR FP FR	FLOOR FIREPROOF FIRE RETAR			PSI PVC PWR	POUND PER SQUARE INCH POLYVINYL CHLORIDE POWER			
ACT ADA ADJ	ACOUSTICAL CEILING TILE AMERICANS WITH DISABILITIES ACT ADJUSTABLE / ADJACENT	FR FT FUR	FIRE RETAN FOOT OR FE FURRING		(Q	POWER			
ADJ AFF ALT	ADJUSTABLE / ADJACENT ABOVE FINISH FLOOR ALTERNATE / ALTERATION	FUR FURN G	FURRING FURNISH/FU	JRNITURE	I	QTR R R	QUARTER			
ALT APROX ARCH	ALTERNATE / ALTERATION APPROXIMATE ARCHITECT / ARCHITECTURAL	GA	GAUGE GENERAL C	ONTRACTOR		R RCP RD	RADIUS REFLECTED CEILING PLAI ROOF DRAIN	ı		
ARCH AVG AWP	ARCHITECT / ARCHITECTURAL AVERAGE ACOUSTIC WALL PANEL	GC GD GEI	GARBAGE [RD REC REF	ROOF DRAIN RECEPTACLE REFRIGERATOR			
	ACOUSTIC WALL PANEL	GFI GL GL B		ZING/GLAZED	JI IEK	REQ	REFRIGERATOR REQUIRED REVISION			
BD BLDG BLK	BUILDING	GLB GND GWB	GLASS BLO GROUND GYPSUM W/			REV RM RO	REVISION ROOM ROUGH OPENING			
BLK BM BO	BLOCK BEAM BY OTHERS	GWB GYP H	GYPSUMW		\$	RO S S	SOUTH		2 REVISIONS AS PER ZONING DEPARTMENT'S REMARKS	2023-
BO BOT BSMT	BY OTHERS BOTTOM BASEMENT	H H HDR	HIGH HEADER			S SCHED SECT	SCHEDULE SECTION		REVISIONS AS PER TOWNSHIP'S REMARKS	2022-
BTWN	BETWEEN	HDWR HR	HARDWARE			SF	SQUARE FEET SHEET		No. Revision Drawing Issue:	Da
CJ CL	CONTROL JOINT CENTER LINE	HT HVAC	HEIGHT	ENTILATION AIR COND	ITIONING	SIM	SIMILAR SPECIFICATION		RE-ISSUE FOR BOA	RN
CLG CLO	CEILING CLOSET	HW	HOT WATER			SQ STD	SQUARE STANDARD		REVIEW 2023-03-0	
CLR CMU	CLEAR CONCRETE MASONRY UNITS	IN INFO	INCHES	ON		STOR STRUCT	STORAGE			10
CO COL	CLEAN OUT COLUMN	INSP INSUL	INSPECTIO	N	1	T T&B	TOP AND BOTTOM		Typical Drawing Legend:	
CONST	CONSTRUCTION CENTER	INT JT	INTERIOR			TBD	TO BE DETERMINED TELEPHONE			NLARGED PL
CU CW	CUBIC COLD WATER	к	KITCHEN			THK	THICK TOP OF WALL		A01.01 TITLE SHEET A06.11 CONSTRUCTION PLANS A11.01 BU A02.01 GENERAL NOTES A07.11 FRAMING/ROOF PLANS A12.01 BU	BUILDING ELE BUILDING SEC MISC. DETAILS REDERINGS
DBL	DOUBLE	L	LEFT / LENG	STH		TV TYP	TELEVISION		A05.11	
DEMO DET	DEMOLITION DETAIL	LB LL	POUND LIVE LOAD		I	UUL	UNDERWRITERS LABORA	TORIES	Drawing Type Drawin Section Number Floor	ing Number
DIA	DIAMETER DIMENSION	LT M	LIGHT			UNF UON	UNFINISHED UNLESS OTHERWISE NOT		Drawing Title/Floor:	
DL DN	DEAD LOAD DOWN	MAX MECH	MAXIMUM MECHANIC	AL	,	V VAR	VARIABLE / VARNISH / VA			
DO DR	DOOR OPENING DOOR	MFR MIN	MANUFACT MINIMUM	URER		VIF VOL	VERIFY IN FIELD VOLUME		TITLE SHEET	
)W)WG	DISHWASHER DRAWING	MIR MISC	MIRROR MISCELLAN	EOUS	١	w w	WEST / WIDE			
E	EAST	MO N	MASONRY	PENING		W/ W/O	WITH WITHOUT			Chk By: MPK
EA EJ	EACH EXPANSION JOINT	N NIC	NORTH NOT IN CON	ITRACT		WAIN WB	WAINSCOT WALL BOARD			lan Nort
ELEC	ELEVATION ELECTRICAL	NO NOM	NUMBER			WC WD	WATER CLOSET WOOD		A01.01	
EMER EP	EMERGENCY ELECTRICAL PANEL/END PANEL	NTS O	NOT TO SC	ALE		WH WIN	WATER HEATER WINDOW			
EQ	EQUAL EXISTING TO REMAIN	OA OC	OVER ALL ON CENTER	1		WP WT	WATERPROOF WEIGHT		THE DRAWING IS (24" X 36"). DRAWINGS WHICH ARE NOT PLOTTED	ob #:
ETR									AT THE SPECIFIED SHEET SIZE ARE NOT TO SCALE. 22	203
etr Exist Ext	EXISTING EXTERIOR	OH OZ	OVERHEAD OUNCE			r YD	YARD		THIS DRAWING AND ITS CONTENTS, INCLUDING BUT NOT	

TAE	BLE	OF CONTENTS	S: CC	DN	STRU	CTIO	N DF	RAV	WING	iS			MICHAEL P. KEATING ARCHITECT	
SHEET NO.		SHEET NAME		ISSUI REVIE 2022-08	W PERMIT	rs Permi	ITS REV		RE-ISSUE: BOARD 2022-12-29	ISSUE	ISSUE	ISSUE	66 GAYWOOD AVENUE COLONIA, NJ 07067	
RCHITE													908-418-2148 MIKEATING1128@ICLOUD.COM	
A02.01		L NOTES & DETAILS		•	•	•		•	•				Seal & Signature:	
A05.01	DEMOLIT	N, ZONING INFO. & PLUMBING RISER DIAG TON PLAN - FIRST FLOOR		•	•	•		•	•				MICHAEL P. KEATINTG, AIA, NCARB NEW JERSEY: 21AI02176600	
	CONSTR	UCTION PLAN - BASEMENT & FIRST FLOOR UCTION PLAN - SECOND FLOOR & ATTIC 3 PLANS & DETAILS - ALL FLOORS		•	•	•		•	•					
A07.02	ROOF PL	AN & FRAMING DETAILS - ALL FLOORS & POWER PLANS - ALL FLOORS		•	•	•		•	•					
A11.01	BUILDIN	G ELEVATIONS G SECTIONS		•	•	•		•	•					
OTAL N	UMBER	OF SHEETS: 11											Typical Graphics Legend:	
OWNER	r informa	AT/ON:											SECTION SURFACE	
NAME:			FRAM		ERIO		<u>Pe of Work:</u> Dlition:						TO BE DEMOLISHED	
PHONE	:		908-4	199-440	0			EXISTIN	IG ROOF AND	ATTIC STRUCTU	JRE.		ELEVATION/SECTION/DETAIL NU SHEET WHERE ELV/SEC/DET IS	JMBER DRAWN
EMAIL:			FLIT	rerio@	MSN.COM	•	REMOVE EXIS	STING EN	NCLOSED FRO	NT PORCH FLO	OR STRUCTURE.		ELEVATION OR SECTION DIREC	TION
						-				EMENT AND ATT	FIC.		NEW DOOR SWING EXISTING DOOR SWING	
PROJE	CT DATA:						REMOVE ALL			ALLS AS NOTE	D.		COUNTERTOP/MILLWORK	
	ISE GROUP	5	R-5			•	REMOVE EXIS	STING BA	ACK DECK, ST	AIRS & CELLAR	DOOR TO BASEMEN	IT.	AREA NOT IN CONTRACT	
• C	ONSTRUC	TION TYPE	V-B			NEW	WORK:							
	LIMATE ZO		4A						-	OF STRUCTURE			EXISTING TO BE DEMOLISHED	GE
		ROUND COVERAGE	1,281 1,281		6Q. FT. 6Q. FT.			-	ST FLOOR AND) SECOND FLOC N.	OR LAYOUT.		DM RR EX EXISTING TO REMAIN EXISTING TO BE REMOVED & RE	ELOCATED
	REA OF W	ORK:								FRONT ENTRY.			Project/Client:	
		FLOOR <u>ND FLOOR</u> L	1,186 <u>1,243</u> 2,429	<u>s</u>	6Q. FT. <u>6Q. FT.</u> 6Q. FT.	•	INSTALL NEW	WINDO	WS THROUGH	IOUT.				
• A	DDITION G	GROUND COVERAGE	N/A		-				LECTRICAL TH				HOUSE RENOVATIONS	
• T(OTAL ADD	ITION FLOOR AREA:	1,243	3 5	SQ. FT.		NEW BACK DI		DRCH & STAIR	S.				
<u>•</u> A	DDITION V	OLUME:	9,944	4 C	CU. FT.								Project Location:	
# & <		POUND OR NUMBER AND ANGLE AT	F FA FD FE FG		FIRE ALARM FLOOR DRAIN FIRE EXTINGL FIBERGLASS			Ρ	PL PLYWD PNL PR	PLATE PLYWOOD PANEL PAIR			CRANFORD, NEW JERSEY BLOCK: 235 LOT: 14	[
¢ Ø		CENTERLINE DIAMETER OR ROUND	FIN		FINISH				PSF PSI		SQUARE FOOT			
A AC ⁻		ACOUSTICAL CEILING TILE	FP	`	FIREPROOF(II				PVC PWR	POLYVINYL C POWER				
AD/ AD	A	AMERICANS WITH DISABILITIES ACT ADJUSTABLE / ADJACENT	FT	२	FOOT OR FEE			Q		QUARTER				
AFF AL1		ABOVE FINISH FLOOR ALTERNATE / ALTERATION	FUF G	RN	FURNISH/FUR	NITURE		R	R	RADIUS				
AR	СН	APPROXIMATE ARCHITECT / ARCHITECTURAL	GA GC		GAUGE GENERAL CO	NTRACTOR			RCP RD	ROOF DRAIN	CEILING PLAN			
AV0 AW		AVERAGE ACOUSTIC WALL PANEL	GD GFI			ILT CIRCUIT IN	TERRUPTER		REC REF	RECEPTACLE				
B BD		BOARD	GL GLE		GLASS/GLAZI GLASS BLOCI				REQ REV	REQUIRED REVISION				
BLI BLI BM	к	BUILDING BLOCK BEAM	GN GW GYI	В	GROUND GYPSUM WAL GYPSUM	L BOARD		6	RM RO	ROOM ROUGH OPEN	NING		REVISIONS AS PER ZONING	23-03-08
BO BO	1	BEAM BY OTHERS BOTTOM	нн	F	HIGH			3	S SCHED	SOUTH SCHEDULE			REVISIONS AS PER TOWNSHIP'S	22-09-30
BSI BT\	МТ	BASEMENT BETWEEN	HDI HDI		HEADER				SECT	SECTION SQUARE FEE	т			Date
C CJ		CONTROL JOINT	HR HT		Hour Height				SHT SIM	SHEET SIMILAR			Drawing Issue:	
CL CLC		CENTER LINE CEILING	HV/ HW		HEATING VEN HOT WATER	ITILATION AIR	CONDITIONIN	IG	SPEC SQ	SPECIFICATIO SQUARE	N		RE-ISSUE FOR BOARL)
CLC CLF	R	CLOSET CLEAR	I IN		INCHES				STD STOR	STANDARD STORAGE			REVIEW 2023-03-08	
CM CO)	CONCRETE MASONRY UNITS CLEAN OUT	INF INS	P		N		т	STRUCT	STRUCTURAL			Typical Drawing Legend:	
	NST	COLUMN CONSTRUCTION	INS INT						T&B TBD	TOP AND BOT			FOR REFERENCE ONLY, REFER TO TITLE SHEET FOR EXACT DRAWING LIST	
CTF CU		CENTER CUBIC	JT K						TEL THK TOW	TELEPHONE THICK TOP OF WALL			A01.01 TITLE SHEET A06.11 CONSTRUCTION PLANS A11.01 BUILDING B A02.01 GENERAL NOTES A07.11 FRAMING/ROOF PLANS A12.01 BUILDING S A03.01 SCHEDULES & DETAILS A08.11 CEILING/POWER PLANS A13.01 MISC. DET/	ELEVATIONS SECTIONS AILS
CW D DBI		COLD WATER DOUBLE	KIT L		KITCHEN	ц			TOW TV TYP	TELEVISION	-		A04.01 SITE/EGRESS PLANS A09.11 FINISH/FURNITURE PLNS A14.01 REDERING	S
DEI	MO	DEMOLITION DETAIL	LB		POUND LIVE LOAD			U			ERS LABORATORIES	1	Drawing Type Drawing Number Section Number Floor	r
DIA	4	DIAMETER DIMENSION	LT		LIGHT				UNF UON	UNFINISHED	ERWISE NOTED		Drawing Title/Floor:	
DL DN		DEAD LOAD DOWN	MAX ME		MAXIMUM MECHANICAL			v	VAR		ARNISH / VARIES			
DO DR	1	DOOR OPENING DOOR	MFI	R	MANUFACTU				VIF VOL	VERIFY IN FIE			TITLE SHEET	
DW DW	I	DISHWASHER DRAWING	MIR	2	MIRROR	ous		W		WEST / WIDE				
E E		EAST	MO N		MASONRY OP				W/ W/O	with Without			Initial Dwg Date: Drawn By: Chk By 2022-07-30 MPK MPK	:
EA EJ		EACH EXPANSION JOINT	N NIC		NORTH NOT IN CONT	RACT			WAIN WB	WAINSCOT WALL BOARD			Dwg #: Plan No	orth:
EL ELE	EC	ELEVATION ELECTRICAL	NO NO	М	NUMBER NOMINAL				WC WD	WATER CLOS WOOD			A01.01	
EMI EP		EMERGENCY ELECTRICAL PANEL/END PANEL	NTS O		NOT TO SCAL	E			WH WIN	WATER HEAT WINDOW				
EQ ETF	R	EQUAL EXISTING TO REMAIN	OA OC		OVER ALL ON CENTER				WP WT	WATERPROO WEIGHT	F		THE SCALE REPRESENTED ON THESE DRAWINGS IS ONLY VALID IF Job #: THE DRAWING IS (24" X 36"). DRAWINGS WHICH ARE NOT PLOTTED Job #: AT THE SPECIFIED SHEET SIZE ARE NOT TO SCALE. 2203	
EXI		EXISTING EXTERIOR	OH OZ		OVERHEAD OUNCE			Y	YD	YARD			THIS DRAWING AND ITS CONTENTS, INCLUDING BUT NOT LIMITE	
													PATENTABLE FEATURES, SEPARATELY OR COLLECTIVELY CONSTITUTE THE ORIGINAL AND UNPUBLISHED PROPERTY OF P. KEATING. THIS DRAWING MAY NOT BE DISCLOSED, REPRO WHOI F OR PART OR FMPLOYED, FOR ANY PURPOSE OTH	MICHAEL DUCED IN

ΤA	BLE	OF CONTENTS	S: CC	ONS	STRU	CTION	DRA	WING	S			MICHAEL P. KEATING ARCHITECT
SHEET NO.		SHEET NAME		ISSUE: REVIEW 022-08-1		S PERMITS	REVIEW	RE-ISSUE BOARD 2022-12-29	ISSUE	ISSUE	ISSUE	66 GAYWOOD AVENUE COLONIA, NJ 07067
RCHIT	ECTUR	AL										908-418-2148 MIKEATING1128@ICLOUD.COM
A01.01 A02.01		RAL NOTES & DETAILS		•	•	•	•	•				Seal & Signature:
A04.01 A05.01	DEMO	LAN, ZONING INFO. & PLUMBING RISER DIAG LITION PLAN - FIRST FLOOR		•	•	•	•	•				MICHAEL P. KEATINTG, AIA, NCARB NEW JERSEY: 21AI02176600
A06.01 A06.02 A07.01	CONS	RUCTION PLAN - BASEMENT & FIRST FLOOR RUCTION PLAN - SECOND FLOOR & ATTIC NG PLANS & DETAILS - ALL FLOORS		• • •	•	•	•	•				
A07.01 A07.02 A08.01	ROOF	PLAN & FRAMING DETAILS - ALL FLOORS PLAN & FRAMING DETAILS G & POWER PLANS - ALL FLOORS		•	•	•	•	•				
A11.01 A12.01	BUILD	ING ELEVATIONS		•	•	•	•	•				
OTAL I	NUMBE	R OF SHEETS: 11				1						Typical Graphics Legend:
OWN	ER INFOR	MATION:										SECTION SURFACE
NAME	:		FRAN	K LITTER	10	<u>SCOPE O</u> DEMOLIT						
PHON	IE:		908-4	99-4400				NG ROOF AND	ATTIC STRUCTU	RE.		ELEVATION/SECTION/DETAIL NUMBER SHEET WHERE ELV/SEC/DET IS DRAWN
EMAI	L:		FLITT	ERIO@M	SN.COM	• REM	IOVE EXISTING E	INCLOSED FRO	ONT PORCH FLOO	OR STRUCTURE		ELEVATION OR SECTION DIRECTION
									EMENT AND ATT	IC.		NEW DOOR SWING
<u>PROJ</u>	IECT DATA	<u>1</u>					IOVE ALL EXISTI		VALLS AS NOTE).		COUNTERTOP/MILLWORK
•	USE GRO	UP	R-5			• REM	IOVE EXISTING E	BACK DECK, ST	AIRS & CELLAR	DOOR TO BASE	MENT.	AREA NOT IN CONTRACT
•	CONSTRU	JCTION TYPE	V-B			NEW WOR	RK:					REVISION NUMBER CLOUD SHOWS AREA OF CHANGE
	CLIMATE		4A	50	CT			-	OF STRUCTURE			EXISTING TO BE DEMOLISHED
		GROUND COVERAGE FLOOR AREA:	1,281 1,281		. FT. . FT.		V KITCHEN LAYO			KLATOUT.		DM RR EX EXISTING TO REMAIN EXISTING TO BE REMOVED & RELOCATED
•		WORK: ST FLOOR	1,186	50	.FT.	• DES	GIGN NEW STAIR	S & LANDING II	N FRONT ENTRY.			Project/Client:
		COND FLOOR	1,100 <u>1,243</u> 2,429	<u>SQ</u>		• INS	TALL NEW WIND	OWS THROUG	IOUT.			
•	ADDITION	I GROUND COVERAGE	N/A				V LIGHTNING & E					HOUSE RENOVATIONS
•	TOTAL AI	DDITION FLOOR AREA:	1,243	SQ.	.FT.		V OPEN FRONT P V BACK DECK RA		6.			
÷	ADDITION	I VOLUME:	9,944	CU	. FT.							Project Location:
<u>ABBR</u> #		POUND OR NUMBER AND	F FA FD		FIRE ALARM FLOOR DRAIN		ł	PL PLYWD	PLATE PLYWOOD			322 MANOR AVENUE CRANFORD, NEW JERSEY BLOCK: 235 LOT: 14
<	9	ANGLE AT	FE FG		FIRE EXTINGU FIBERGLASS	IISHER		PNL PR	PANEL PAIR			
¢ Ø	i	CENTERLINE DIAMETER OR ROUND	FIN FLR FP		FINISH FLOOR FIREPROOF(IN			PSF PSI PVC	POUND PER S POUND PER S POLYVINYL C	QUARE INCH		
	CT DA	ACOUSTICAL CEILING TILE AMERICANS WITH DISABILITIES ACT	FF FR FT		FIRE RETARDA	ANT		PWR Q	POULTVINTE C	ILURIDE		
Α	DJ FF	ADJUSTABLE / ADJACENT ABOVE FINISH FLOOR	FUR		FURRING FURNISH/FUR			QTR R	QUARTER			
Α	LT PROX	ALTERNATE / ALTERATION APPROXIMATE	G GA		GAUGE			R RCP	RADIUS REFLECTED C	EILING PLAN		
	RCH VG	ARCHITECT / ARCHITECTURAL AVERAGE	GC GD		GENERAL CON GARBAGE DIS			RD REC	ROOF DRAIN RECEPTACLE			
A B	WP	ACOUSTIC WALL PANEL	GFI GL		GLASS/GLAZI		RUPTER	REF REQ	REFRIGERAT(REQUIRED	DR		
	LDG	BOARD BUILDING	GLB GNE)	GLASS BLOCK GROUND			REV RM	REVISION ROOM			
В	LK M	BLOCK BEAM	GWE GYP		GYPSUM WALI GYPSUM	L BOARD	\$	RO S	ROUGH OPEN	ING		2 REVISIONS AS PER ZONING DEPARTMENT'S REMARKS 2023-03-08
	от	BY OTHERS BOTTOM	Н		HIGH			S SCHED	SOUTH SCHEDULE			1 REVISIONS AS PER TOWNSHIP'S 2022-09-30
В	SMT TWN	BASEMENT BETWEEN	HDR HDV	VR	HEADER HARDWARE HOUR			SECT SF SHT	SECTION SQUARE FEET SHEET	ſ		No. Revision Date Drawing Issue:
C C C		CONTROL JOINT CENTER LINE	HR HT HVA		HEIGHT	TILATION AIR CON		SIM	SIMILAR	N		RE-ISSUE FOR BOARD
C	LG LO	CEILING CLOSET	HW		HOT WATER			SQ STD	SQUARE			REVIEW 2023-03-08
C	LR MU	CLEAR CONCRETE MASONRY UNITS	IN INFO		INCHES INFORMATION	1		STOR STRUCT	STORAGE STRUCTURAL			
C	O OL	CLEAN OUT COLUMN	INSI	Р	INSPECTION INSULATION		T	Г T&B	TOP AND BOT			Typical Drawing Legend:
	ONST TR	CONSTRUCTION CENTER	INT JT		INTERIOR JOINT			TBD TEL	TO BE DETER TELEPHONE	MINED		FOR REFERENCE ONLY, REFER TO TITLE SHEET FOR EXACT DRAWING LIST A00.01 COVER SHEET A05.11 DEMOLITION PLANS A10.01 ENLARGED PLANS A01.01 TITLE SHEET A06.11 CONSTRUCTION PLANS A11.01 BUILDING ELEVATIONS
C C		CUBIC COLD WATER	к кіт		KITCHEN			THK TOW	THICK TOP OF WALL			A01.01 THE STEET A00.11 CONSTRUCTION FLANS A11.01 BUILDING ELEVATIONS A02.01 GENERAL NOTES A07.11 FRAMING/ROOP FLANS A12.01 BUILDING SECTIONS A03.01 SCHEDULES & DETAILS A08.11 CELING/POWER PLANS A13.01 MISC. DETAILS A04.01 SITE/EGRESS PLANS A09.11 FINISH/FURNITURE PLNS A14.01 REDERINGS
	BL	DOUBLE	LL		LEFT / LENGTH	н		TV TYP	TELEVISION TYPICAL			
D	emo et	DEMOLITION DETAIL	LB LL		POUND LIVE LOAD		I	J UL		RS LABORATO	RIES	Drawing Type Drawing Number Drawing Number Floor
D	IA IM	DIAMETER DIMENSION	LT M		LIGHT			UNF UON	UNFINISHED UNLESS OTH	ERWISE NOTED		Drawing Title/Floor:
D		DEAD LOAD DOWN	MAX	н	MAXIMUM MECHANICAL		· · · · ·	VAR		ARNISH / VARIE	S	
D	R	DOOR OPENING DOOR DISHWASHER	MFR MIN			KEK		VIF VOL	VERIFY IN FIE VOLUME	LU		
D	W WG	DISHWASHER DRAWING	MIR MIS(С	MIRROR MISCELLANEC		1	N W	WEST / WIDE			
EE	Δ	EAST EACH	MO N N		MASONRY OPE			W/ W/O WAIN	WITH WITHOUT WAINSCOT			Initial Dwg Date:Drawn By:Chk By:2022-07-30MPKMPK
E E E	J	EACH EXPANSION JOINT ELEVATION	N NIC NO		NORTH NOT IN CONTR NUMBER	RACT		WAIN WB WC	WAINSCOT WALL BOARD WATER CLOS	FT		Dwg #: Plan North:
E	l Lec Mer	ELECTRICAL EMERGENCY	NO NON NTS	Λ	NOMINAL NOT TO SCALE	E		WD WH	WOOD WATER HEAT			A01.01
	Р	ELECTRICAL PANEL/END PANEL EQUAL	0 0		OVER ALL	_		WIN WP	WINDOW			
E	TR XIST	EXISTING TO REMAIN EXISTING	OC OH		ON CENTER OVERHEAD		,	WT Y	WEIGHT			THE SCALE REPRESENTED ON THESE DRAWINGS IS ONLY VALID IF Job #: THE DRAWING IS (24" X 36"). DRAWINGS WHICH ARE NOT PLOTTED Job #: AT THE SPECIFIED SHEET SIZE ARE NOT TO SCALE. 2203
	XT	EXTERIOR	OZ		OUNCE			YD	YARD			THIS DRAWING AND ITS CONTENTS, INCLUDING BUT NOT LIMITED TO ALL PATENTABLE FEATURES, SEPARATELY OR COLLECTIVELY SHOWN,
												CONSTITUTE THE ORIGINAL AND UNPUBLISHED PROPERTY OF MICHAEL P. KEATING. THIS DRAWING MAY NOT BE DISCLOSED, REPRODUCED IN

ABL	E OF CONTENT	S: CON	STRUC	TION	DRA	WING	S			MICHAEL P. KEATING ARCHITECT	
EET O.	SHEET NAME	ISSUE REVIE 2022-08	W PERMITS	RE-ISSUE: PERMITS 2022-10-11	ISSUE: REVIEW 2022-12-29	RE-ISSUE: BOARD 2022-12-29	ISSUE	ISSUE	ISSUE	66 GAYWOOD AVENUE COLONIA, NJ	
HITECTL	IRΔI		2022 00 10			1 2022 12 20	1			07067 908-418-2148	
1.01 TITI	LE SHEET NERAL NOTES & DETAILS	•	•	•	•	•				MIKEATING1128@ICLOUD.COM	
4.01 SIT	E PLAN, ZONING INFO. & PLUMBING RISER DIAG MOLITION PLAN - FIRST FLOOR	GRAM •	•	•	•	•				MICHAEL P. KEATINTG, AIA, NCARB	
6.02 COI	NSTRUCTION PLAN - BASEMENT & FIRST FLOOF NSTRUCTION PLAN - SECOND FLOOR & ATTIC	•	•	•	•	•				NEW JERSEY: 21AI02176600	
7.02 RO	MING PLANS & DETAILS - ALL FLOORS DF PLAN & FRAMING DETAILS LING & POWER PLANS - ALL FLOORS	•	•	•	• • •	•					
1.01 BUI	LDING ELEVATIONS	•	•	•	•	•					
AL NUME	BER OF SHEETS: 11									Typical Graphics Legend:	
OWNER INF	ORMATION:			SCOPE OF N						SECTION SURFACE EXISTING TO TO BE DEMOI	
NAME:		FRANK LITTI	ERIO	DEMOLITION							
PHONE: Email:		908-499-440 FLITTERIO@		• REMO	/E ALL EXISTII	NG ROOF AND	ATTIC STRUCTU	RE.			ECTION/DETAIL NUMBER RE ELV/SEC/DET IS DRAWN DR SECTION DIRECTION
		1 ETTENIO					NT PORCH FLOO			NEW DOOR S	
						NG WINDOWS.		10.			OR SWING
PROJECT D	<u>47A:</u>			• REMO	/E ALL EXISTII	NG INTERIOR V	ALLS AS NOTED).		COUNTERTO	?/MILLWORK
USE G		R-5				ACK DECK, ST	AIRS & CELLAR I	DOOR TO BASE	MENT.	AREA NOT IN	CONTRACT
	IRUCTION TYPE TE ZONE	V-B 4A		NEW WORK:		R, ATTIC & RO	OF STRUCTURE A	AS NOTED.		REVISION NU CLOUD SHOW	IMBER VS AREA OF CHANGE
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	ION GROUND COVERAGE . ADDITION FLOOR AREA:	N/A 1,243 S	Q. FT.	• NEW 0	PEN FRONT P	ORCH & STAIR	S.			HOUSE RENOVA	TIONS
	ION VOLUME:	·	U. FT.	• NEW B	ACK DECK RA	ILING.				Project Location:	
BBRIVIATIO	DNS:									322 MANOR AV CRANFORD, NEW	
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& <	AND ANGLE	FD FE	FLOOR DRAIN FIRE EXTINGUIS	HER		PLYWD PNL	PLYWOOD PANEL				
@ ¢	AT CENTERLINE	FG FIN	FIBERGLASS FINISH			PR PSF	PAIR POUND PER S				
Ø		FLR FP	FLOOR FIREPROOF(ING)			PSI PVC	POUND PER S				
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ADJ AFF ALT	ADJUSTABLE / ADJACENT ABOVE FINISH FLOOR ALTERNATE / ALTERATION	FUR FURN G	FURNISH/FURNI	TURE	F	QTR R R	QUARTER RADIUS				
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AVG AWP	AVERAGE ACOUSTIC WALL PANEL	GD GFI	GARBAGE DISPO		PTER	REC REF	RECEPTACLE REFRIGERATO	DR			
BD	BOARD	GL GLB	GLASS/GLAZING GLASS BLOCK	/GLAZED		REQ REV	REQUIRED REVISION				
BLDG BLK	BUILDING BLOCK	GND GWB	GROUND GYPSUM WALL B	OARD		RM RO	ROOM ROUGH OPEN	ING		REVISIONS AS PER ZONING	
BM BO BOT	BEAM BY OTHERS BOTTOM	GYP H H	GYPSUM HIGH		S	S SCHED	SOUTH SCHEDULE			DEPARTMENT'S REMARKS	2023-03-08
BSMT BTWN	BASEMENT BETWEEN	HDR HDWR	HEADER HARDWARE			SECT	SECTION SQUARE FEET			No. Revision	
CJ	CONTROL JOINT	HR HT	HOUR HEIGHT			SHT	SHEET			Drawing Issue:	
CL CLG	CENTER LINE CEILING	HVAC HW	HEATING VENTIL HOT WATER	ATION AIR CONDI	TIONING	SPEC SQ	SPECIFICATIO SQUARE	N		RE-ISSUE FOR	
CLO CLR	CLOSET CLEAR	I IN	INCHES			STD STOR	STANDARD STORAGE			REVIEW 2023-	03-08
CMU CO	CONCRETE MASONRY UNITS CLEAN OUT COLUMN	INFO INSP	INFORMATION INSPECTION INSULATION		т	STRUCT	STRUCTURAL			Typical Drawing Legend:	
COL CONST CTR	CONSTRUCTION CENTER	INSUL INT JT	INTERIOR			T&B TBD TEL	TOP AND BOT TO BE DETERM TELEPHONE			FOR REFERENCE ONLY, REFER TO TITLE SHEET FOR EXACT DRAWIN A00.01 COVER SHEET A05.11 DEMOLITION PLANS	NG LIST A10.01 ENLARGED PLANS
CU CW	CUBIC COLD WATER	к	KITCHEN			THK	THICK TOP OF WALL			A01.01 TITLE SHEET A06.11 CONSTRUCTION PLANS A02.01 GENERAL NOTES A07.11 FRAMING/ROOF PLANS A03.01 SCHEDULES & DETAILS A08.11 CEILING/POWER PLANS A04.01 SITE/EGRESS PLANS A09.11 FINISH/FURNITURE PLNS	A11.01 BUILDING ELEVATIONS A12.01 BUILDING SECTIONS A13.01 MISC. DETAILS A14.01 REDERINGS
DBL	DOUBLE	L	LEFT / LENGTH			TV TYP	TELEVISION TYPICAL			A05.11	
DEMO DET	DEMOLITION DETAIL	LB LL	POUND LIVE LOAD		ι	UL		RS LABORATOR	RIES	Drawing Type	Drawing Number Floor
DIA DIM	DIAMETER DIMENSION	LT M	LIGHT		V	UNF UON	UNFINISHED UNLESS OTHE	RWISE NOTED		Drawing Title/Floor:	
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DO DR DW	DOOR OPENING DOOR DISHWASHER	MFR MIN MIR	MINIMUM		v	VOL	VOLUME			TITLE SHEE	. 1
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E EA	EAST EACH	N N	NORTH			W/O WAIN	WITHOUT WAINSCOT			2022-07-30 MPK	Plan North:
EJ EL	EXPANSION JOINT ELEVATION	NIC NO	NOT IN CONTRAC	СТ		WB WC	WALL BOARD WATER CLOSE	ET			
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		UL UL	JUNUL			.5				THIS DRAWING AND ITS CONTENTS, INCLUDING PATENTABLE FEATURES, SEPARATELY OR CONSTITUTE THE ORIGINAL AND UNPUBLISHED P. KEATING. THIS DRAWING MAY NOT BE DISC	COLLECTIVELY SHOWN, D PROPERTY OF MICHAEL
									•	WHOLE OR PART OR EMPLOYED FOR ANY	LOSED, REFROND FITTIN

GENERAL NOTES - ALL TRADES:

- ALL WORK PERFORMED BY THE CONTRACTOR/ SUB-CONTRACTORS SHALL CONFORM TO THE REQUIREMENTS OF LOCAL, MUNICIPAL, STATE & FEDERAL LAWS, AS WELL AS ANY OTHER GOVERNING AGENCIES, WHETHER OR NOT SPECIFIED ON THE DRAWINGS.
- THE CONTRACTOR/SUBCONTRACTORS SHALL APPLY FOR & OBTAIN ALL LEGALLY REQ'D APPROVALS & PERMITS NECESSARY FOR THE EXECUTION & COMPLETION OF ALL THEIR WORK.
- EACH CONTRACTOR SHALL CHECK & VERIFY ALL DIMENSIONS & CONDITIONS ON THE JOB SITE & SHALL NOTIFY ARCHITECT OF ANY DISCREPANCIES BETWEEN THE DRAWINGS, NOTES & FIELD CONDITIONS BEFORE COMMENCING ANY WORK TO REQUEST CLARIFICATION.
- NO SUBSTITUTIONS WILL BE ACCEPTED UNLESS SUBMITTED IN WRITING TO ARCHITECT & APPROVED BY ARCHITECT & OWNER IN WRITING.
- THE G.C. IS TO NOTIFY ARCHITECT IN WRITING OF ANY ADAPTATIONS TO THESE DWGS OR SPECIFICATIONS REQ'D BY LOCAL LIFE & SAFETY CODES OR ANY OTHER GOVERNING AGENCY.
- IT IS THE RESPONSIBILITY OF THE CONTRACTOR, ALL THE SUB-CONTRACTORS AND SUBORDINATE SUB-CONTRACTORS TO THOROUGHLY REVIEW ALL PLANS DRAWINGS, AND TITLE, LEGEND AND NOTES PAGES, DETAIL DRAWINGS, ETC. ISSUED AS PART OF THIS SET OF CONSTRUCTION DOCUMENTS IN ORDER TO FULLY UNDERSTAND THE SCOPE OF THEIR WORK AS WELL AS TO FULLY UNDERSTAND THE WORK OF OTHER TRADES AS IT MAY EFFECT THEIR WORK. THE SUBMISSION OF A BID WILL BE DEEMED EVIDENCE FACT THAT ALL CONSTRUCTION DOCUMENTS HAVE BEEN REVIEWED. NO CLAIM OF ADDITIONAL EXPENSE WILL BE ACCEPTED FROM THE CONTRACTOR OR SUB-CONTRACTOR OR SUBORDINATE SUB-CONTRACTOR WHO HAS FAILED TO FAMILIARIZE ITSELF WITH THE WORK OF OTHER TRADES.

STRUCTURAL DATA:

(LOADS INDICATED ARE IN POUNDS PER SQUARE FOOT AND WERE USED TO **DESIGN STRUCTURAL MEMBERS)**

•	FIRST & SECOND FLOORS:		
	LIVE LOAD	40	PSF
	DEAD LOAD	12	PSF
	TOTAL LOAD	52	PSF
•	SLEEPING ROOMS:		
	LIVE LOAD	30	PSF
	DEAD LOAD	<u>12</u>	<u>PSF</u>
	TOTAL LOAD	42	PSF
•	ATTIC FLOOR:		
	LIVE LOAD	20	PSF
	DEAD LOAD	<u>12</u>	PSF
	TOTAL LOAD	32	PSF
•	ROOF LOAD:		
	SNOW LOAD	30	PSF
	DEAD LOAD	<u>12</u>	<u>PSF</u>
	TOTAL LOAD	42	PSF
•	STAIR LOAD:		
	LIVE LOAD	40	PSF
	DEAD LOAD	<u>12</u>	<u>PSF</u>
	TOTAL LOAD	52	PSF
•	EXTERIOR WOOD DECK LOAD:		
	LIVE LOAD	40	PSF
	DEAD LOAD	<u>12</u>	<u>PSF</u>
	TOTAL LOAD	52	PSF
•	EXTERIOR BALCONY LOAD:		
	LIVE LOAD	60	PSF
	DEAD LOAD	<u>12</u>	<u>PSF</u>
	TOTAL LOAD	72	PSF

GENERAL CONDITIONS:

- USE OF DRAWINGS: THESE DRAWINGS ARE THE PROPERTY OF THE ARCHITECT AND SHALL NOT BE USED WITHOUT HIS CONSENT. DRAWINGS SHALL NOT BE USED FOR ISSUE OF BUILDING PERMIT UNLESS SIGNED AND SEALED BY THE ARCHITECT
- NO DEVIATIONS FROM THE WORK SHOWN OR REASONABLY IMPLIED SHALL BE UNDERTAKEN WITHOUT THE ARCHITECT'S WRITTEN CONSENT. A COPY OF WHICH WILL BE FILED WITH THE CONSTRUCTION OFFICIAL.
- THESE DRAWINGS ARE IN COMPLIANCE WITH THE ARCHITECT'S INTERPRETATION OF THE CURRENT NEW JERSEY UNIFORM CONSTRUCTION CODE AND THE INTERNATIONAL RESIDENTIAL CODE 2018. NEW JERSEY EDITION . IT IS ASSUMED THAT WHEN A BUILDING PERMIT IS ISSUED BY THE BUILDING INSPECTOR, THAT THEY HAVE THOROUGHLY EXAMINED THE DRAWINGS AND SPECIFICATIONS ACCORDING TO THE IRC NEW JERSEY EDITION CODE REQUIREMENTS. ANY CHANGES, ADDITIONS, ETC., MADE BY ANY PARTY DURING CONSTRUCTION SHALL BE THE RESPONSIBILITY OF THE PERSON(S) MAKING SUCH CHANGES.
- **REGULATORY REQUIREMENTS:** THESE CONTRACT DOCUMENTS WERE PREPARED IN ACCORDANCE WITH THE NEW JERSEY STATE UNIFORM CONSTRUCTION CODE. THE CONTRACTOR SHALL CONFORM TO THIS AND OTHER APPLICABLE LOCAL. COUNTY, STATE AND FEDERAL CODES, LAWS, REGULATIONS, ORDINANCES AND REQUIREMENTS.
- CHANGES: ANY CHANGES TO OR DEVIATIONS FROM THESE DRAWINGS SHALL NOT BE MADE WITHOUT WRITTEN CONSENT FROM THE ARCHITECT.
- CHANGES TO THE PLANS BY THE OWNER AND CONTRACTOR SHALL BE THE **RESPONSIBILITY OF THE PERSONS MAKING SUCH CHANGES.**
- MANUFACTURER'S SPECIFICATIONS: WHEREVER THEY ARE NOT IN CONFLICT WITH THESE SPECIFICATIONS. ALL MATERIALS SHALL BE INSTALLED IN STRICT ACCORDANCE WITH THE MANUFACTURER'S WRITTEN SPECIFICATION OR MATERIALS INSTITUTE. WHERE MANUFACTURER'S SHALL BE RESPONSIBLE FOR THE PERFORMANCE OF THEIR PRODUCT AND SHALL INDEMNIFY AND SAVE HARMLESS THE OWNER, ARCHITECT, AND GENERAL CONTRACTOR IN CASE OF FAILURE.
- THESE SPECIFICATIONS ARE INTENDED TO SUPPLEMENT THE WORKING DRAWINGS WHICH TOGETHER ARE TO BE USED FOR PERFORMING THE WORK.
- WHERE THE SPECIFICATIONS DISAGREE WITH THE DRAWINGS, THE DRAWINGS SHALL SUPERSEDE.
- DRAWINGS: DO NOT SCALE DRAWINGS, FOLLOW WRITTEN DIMENSIONS. NOTIFY ARCHITECT OF ANY DISCREPANCIES PRIOR TO COMMENCING WORK. CONSTRUCTION NOTES ON DRAWINGS ARE INCLUSIVE OF ALL TRADES AND SHALL BE READ AND UNDERSTOOD BY ALL CONTRACTORS AND SUBCONTRACTORS.
 - DETAILS SHOWN IN ANY SECTION APPLY TO ALL SIMILAR SECTIONS UNLESS OTHERWISE NOTED.
- SAFETY: ALL CONTRACTORS TO PROVIDE ALL NECESSARY BARRICADES AND SAFETY PRECAUTIONS AND STRICTLY ADHERE TO ALL GOVERNING CODES ON SAFETY, INCLUDING STATE, LOCAL AND THE OSHA ACT.

<u>GENERAL REQUIREMENTS.</u>

- ALL MATERIAL AND EQUIPMENT SHALL BE APPROVED FOR USE AS REQUIRED BY GOVERNING MUNICIPAL, STATE AND/OR FEDERAL AGENCIES AND SHALL BEAR ALL REQUIRED CONDITIONS.
- EXISTING CONDITIONS: (IF APPLICABLE) ALL CONDITIONS AND DIMENSIONS SHALL BE VERIFIED BY THE CONTRACTOR PRIOR TO THE START OF CONSTRUCTION. THE CONTRACTOR SHALL REPORT, IN WRITING, DISCREPANCIES TO THE ARCHITECT IMMEDIATELY UPON DISCOVERY OF SUCH CONDITIONS.

2. <u>SITE WORK:</u>

- SUBSURFACE INVESTIGATION: SOIL NOTE: FOOTINGS ARE DESIGNED FOR A MINIMUM SOIL BEARING CAPACITY OF 3000 PSF. THE CONTRACTOR SHALL INVESTIGATE THE SUBSURFACE TO ENSURE THE SOIL HAS A SAFE BEARING CAPACITY OF 3000 PSF. FOOTING ELEVATIONS SHALL BE ADJUSTED TO ACTUAL LEVELS OF ACCEPTABLE BEARING STRATA FOUND UPON EXCAVATION. NOTIFY ARCHITECT OF ANY UNUSUAL CONDITIONS.
- BUILDING DEMOLITION: (IF APPLICABLE) DEMOLISH BUILDING TO THE EXTENT INDICATED ON DRAWINGS. FILL ALL EXCAVATIONS AND COMPACT SOIL TO 95%.
- SELECTIVE DEMOLITION: (IF APPLICABLE) SELECTIVE PORTIONS OF THE INTERIOR AND EXTERIOR OF THE BUILDING, INCLUDING PLUMBING, ELECTRICAL, HEATING AND COOLING SYSTEMS, ARE TO BE REMOVED AND THE REMAINING PORTIONS ARE TO BE PATCHED TO MATCH AND LINE-UP WITH REMAINING ADJACENT SURFACES. REMOVE ABOVE AND BELOW GRADE CONSTRUCTION WHICH WILL INTERFERE WITH THE PROPOSED ADDITION
- EARTHWORK: STRIP AND STOCKPILE TOPSOIL FOR LATER REDISTRIBUTION WHEN FINE GRADING IS DONE. SPREAD SOIL, HAND GRADE AND SEED LAWN. EXCESS EXCAVATED MATERIALS SHALL BE DISTRIBUTED IN SUCH A WAY AS TO PROVIDE A SMOOTH TRANSITION TO UNDISTURBED GRADE. PROVIDE CLEAN FILL AS REQUIRED TO BRING FINISHED GRADE TO REQUIRED LEVEL. SLOPE GRADES AWAY FROM BUILDING. FINISHED GRADE SHALL BE A MINIMUM OF 18" **BELOW ANY WOOD FRAMING.**
- EXCAVATION, BACKFILLING AND COMPACTING: EXCAVATE AS REQUIRED TO INSTALL FOOTINGS AND TO MAINTAIN FINISH FLOOR ELEVATION. BACKFILL WITH CLEAN SOIL, FREE OF DELETERIOUS MATERIALS, FINISH GRADE AROUND NEW CONSTRUCTION AND SLOPE GRADE AWAY FROM BUILDING. COMPACT SOIL IN AREAS TO RECEIVE CONCRETE FLOORS OR SLABS TO 95%. DO NOT BACKFILL AGAINST FOUNDATION WALLS UNTIL ALL FIRST FLOOR FRAMING IS COMPLETE.
- FROST AND SLOPE PROTECTION: BOTTOM OF EXTERIOR FOOTINGS SHALL BE A MINIMUM OF 3'-0" BELOW FINISHED GRADE FOR FROST PROTECTION. MAXIMUM SLOPE BETWEEN THE BOTTOM OF ADJACENT FOOTINGS SHALL BE A RATIO OF ONE(1) VERTICAL TO TWO (2) HORIZONTAL.

<u>CONCRETE :</u>

- CONCRETE REINFORCEMENT: AS NOTED ON DRAWINGS.
- **REINFORCING:** ALL REINFORCING BARS SHALL BE NEW BILLET STEEL DEFORMED TYPE, ASTM A615 GRADE 40 AND SHALL COMPLY W/ ALL ACI CODE REQUIREMENTS. LENGTH OF REINFORCING SPLICES SHALL CONFORM TO ACI BUILDING CODE REQUIREMENTS, BUT IN NO CASE LESS THAN 1" FROM THE TOP AND OVER ANY PIPES, AND CONDUITS IN SLAB.
- MASONRY CONTRACTOR IS TO PROVIDE ALL NECESSARY SCREEDING DEVICES FOR THE PROPER INSTALLATION OF ALL REINFORCING.
- CAST-IN-PLACE CONCRETE: ULTIMATE STRENGTH OF CONCRETE FOOTINGS SHALL BE NOT LESS THAN 3000 PSI, IN 28 DAYS, FOOTINGS TO BE A MINIMUM OF 3'-0" BELOW FINISHED GRADE AND REST ON FIRM UNDISTURBED SOIL. (UNLESS OTHERWISE NOTED ON DRAWINGS.)
- ULTIMATE STRENGTH OF CONCRETE SLABS ON GRADE IN GARAGE AREAS AND APRONS SHALL BE NOT LESS THAN 3500 PSI. IN 28 DAYS, WITH 6X6-10/10 WELDED WIRE MESH SET MIDWAY IN SLAB UNLESS OTHERWISE NOTED ON THE DRAWINGS.
- FILL ALL CONCRETE MASONRY UNITS SOLID WITH CONCRETE UNDER ALL WOOD POSTS FROM ABOVE.
- NO CONCRETE SHALL BE POURED IN FREEZING WEATHER, ON FROZEN OR WET GROUND, OR WHILE IT IS RAINING.

4. <u>MASONRY:</u>

- CONCRETE MASONRY UNITS: FOUNDATION WALLS SHALL BE HOLLOW LOAD BEARING CONCRETE BLOCK CONFORMING TO ASTM C90, GRADE N, TYPE I. MORTAR FOR MASONRY UNITS SHALL BE TYPE M OR S.
- HORIZONTAL MASONRY JOINT REINFORCING: TRUSS TYPE REINFORCING TO BE 3/16" LONGITUDINAL RODS, WITH NO. 9 GAUGE CROSS RODS.
- WHERE BRICK AND/OR STONE VENEER IS INDICATED ON DRAWINGS, REINFORCING TIES, COPINGS, LOOSE LINTELS, ANCHORS AND FLASHING SHALL BE INCLUDED.
- GLASS BLOCK: PROVIDE AND INSTALL GLASS BLOCK UNITS AS INDICATED ON PLAN, AS MANUFACTURED BY PITTSBURGH CORNING CORP. GLASS BLOCK SPECIFICATIONS AS PROVIDED BY MANUFACTURER.
- STORAGE: ALL MASONRY MATERIALS SHALL BE STORED IN A NEAT MANOR HIGH AND DRY FROM ALL FOREIGN MATERIAL AND PROTECTED FROM MOISTURE.


<u>METALS</u>


- METAL FASTENING: ANCHOR BOLTS 1/2" DIAMETER X 18" LONG AT 8'-0" O.C. AND 12" FROM EACH CORNER OR APPROVED ANCHORING SYSTEM AS PER SECTION R403.1.6 OF THE INTERNATIONAL RESIDENTIAL CODE 2018 NEW JERSEY FDITION
- STRUCTURAL METAL FRAMING: ALL LALLY COLUMNS SHALL BE OF STANDARD STEEL PIPE WITH FY=36KSI AS FOUND IN THE "MANUAL OF STEEL CONSTRUCTION" UNLESS OTHERWISE NOTED.
- ALL COLUMN BASE PLATES AND BEARING PLATES TO BE 5" X 5" X 3/16" THICK A-36 STEEL UNLESS OTHERWISE NOTED.
- STEEL LINTELS: (SEE DRAWINGS FOR SIZE AND SPECIFICATIONS)
- ALL MATERIAL AND WORKMANSHIP SHALL BE IN ACCORDANCE WITH THE STANDARD SPECIFICATIONS OF THE AMERICAN INSTITUTE OF STEEL CONSTRUCTION. ALL WORK TO RECEIVE ONE SHOP COAT OF PAINT.
- HANDRAILS AND GUARDS: ALL GUARDS AND HANDRAILS TO COMPLY WITH SPECIFICATIONS SET FORTH IN INTERNATIONAL RESIDENTIAL CODE 2018, NEW JERSEY EDITION SECTIONS R311.7.8 AND R312

WOODS AND PLASTICS
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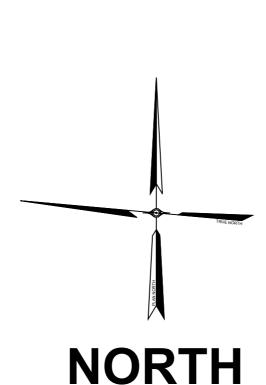
- ROUGH CARPENTRY: FOR LUMBER, PROVIDE S4SK, SDRY, GRADE MARKED AND COMPLYING WITH PS 20. STRUCTURAL LUMBER SHALL BE SOUTHERN YELLOW PINE AND CONFORM TO THE FOLLOWING: FB-1250 PSI (SINGLE MEMBER), FB-1450 PSI (REPETITIVE MEMBER), E-1,600,000 PSI, FV-95 PSI. ALL LUMBER IN CONTACT WITH MASONRY, EXPOSED TO WEATHER OR AS INDICATED ON THE DRAWINGS SHALL BE PRESSURE TREATED TO COMPLY WITH AWPA C2 AND C9. SIZES OF LUMBER ARE INDICATED ON DRAWINGS.
- PLYWOOD: PROVIDE PLYWOOD WITH AMERICAN PLYWOOD ASSOCIATION GRADE STAMP ON EACH SHEET, INDICATING THE SPAN RATING, EXPOSURE DURABILITY CLASSIFICATION, THICKNESS, AND GRADE DESIGNATIONS. PLYWOOD SHALL COMPLY WITH THE REQUIREMENTS OF PS-1-83. THE FOLLOWING MINIMUM THICKNESS AND GRADE DESIGNATIONS SHALL BE PROVIDED FOR THE APPLICABLE LOCATIONS. WHERE THE DRAWINGS INDICATE A DIFFERENT THICKNESS, THE LARGER THICKNESS SHALL BE INSTALLED.
- PREFABRICATED WOOD BEAMS: PROVIDE PRE-MANUFACTURED PARALLEL LAMINATED VENEER LUMBER USING 1/8" THICK DOUGLAS FIR VENEERS GLUED WITH ALL GRAIN PARALLEL TO THE LENGTH OF THE BEAM. BEAMS ARE DESIGNATED ON DRAWINGS AS "MICRO-LAM" AND SHALL BE OF SINGLE PIECE LENGTH AND CONFORM TO THE FOLLOWING: FB-2800 PSI, E-2,000,000 PSI, AND FV-285 PSI. SIZES ARE INDICATED ON THE DRAWINGS.
- APPLICATIONS: ALL HEADERS SHALL BE A MINIMUM OF (2) 2"X10" WITH 2"X4" BOTTOM LINER UNLESS OTHERWISE NOTED OR AS PRESCRIBED IN THE INTERNATIONAL RESIDENTIAL CODE 2018, NEW JERSEY EDITION SECTIONS R602.7 AND TABLE R602.7(1).
- ALL CEILING BEAMS SHALL BE HUNG WITH 2"X4" 16" O.C. HANGERS, IF CLEAR SPAN EXCEEDS 12'-0".
- JOISTS AND BEAMS SHALL BEAR ON A MINIMUM OF 3 1/2" BASE. PROVIDE JOISTS 6" APART UNDER PLUMBING OR UTILITY WALLS (TYPICAL).
- ALL JOISTS FRAMING INTO FLUSH HEADERS OR TRIMMERS SHALL BE HUNG FROM "SIMPSON STRONG TIE" METAL JOIST HANGERS OR APPROVED EQUAL.
- DOUBLE ALL JOISTS UNDER ALL PARTITIONS PARALLEL TO FLOOR JOISTS, UNDER TUBS AND AROUND ALL OPENINGS.
- IN BEARING WALLS, HEADERS SHALL REST ON DOUBLE JACK STUD, EACH SIDE OR AS STIPULATED IN THE INTERNATIONAL RESIDENTIAL CODE 2018, NEW JERSEY EDITION TABLE R602.7(1)
- PROVIDE WOOD "BLOCKING" MIDWAY IN ALL BEARING WALLS.
- PROVIDE A SILL SEALER ON TOP OF FOUNDATION WALLS BELOW TREATED WOOD SILLS.
- PROVIDE SOLID OR "X" TYPE BRIDGING AT 8'-0" ON CENTER, MAXIMUM BETWEEN ALL FLOOR JOISTS.
- IF USED, ALL WOOD ROOF TRUSSES SHALL BE DESIGNED AND GUARANTEED BY THE MANUFACTURER OF SAME. ALL DESIGN CALCULATIONS SHALL BE IN STRICT ACCORDANCE WITH THE S.U.C.C. CODE OF NEW JERSEY AND SEALED BY A N.J. LICENSED ENGINEER AND SUBMITTED TO THE BUILDING DEPARTMENT, OWNER AND ARCHITECT.
- IF USED, FLITCH PLATE BEAMS SHALL BE ASSEMBLED WITH 3/4" DIAMETER CARRIAGE TYPE BOLTS SPACED AT 2'-0" O.C., STAGGERED, DOUBLE BOLTS AT ENDS, UNLESS OTHERWISE NOTED.
- PROVIDE DRAFTSTOPPING AND FIRESTOPPING AT MAXIMUM 8'-0" O.C. VERTICALLY IN ALL CHASES AND STACKS, ETC., AS PER LOCAL CODES.
- THERMAL & MOISTURE PROTECTION
- BITUMINOUS DAMPPROOFING: PROVIDE COLD ASPHALT DAMPPROOFING OF THE SEMI-FIBRATED TYPE CONFORMING TO FS SS-A-694 TO ALL BELOW GRADE MASONRY SURFACES. SUBMIT PRODUCT DATA. INSTALL IN ACCORDANCE WITH MANUFACTURER'S PRINTED INSTRUCTIONS
- CEMENTITIOUS DAMPPROOFING: ON ALL EXTERIOR ABOVE AND BELOW GRADE CONCRETE MASONRY UNIT SURFACES PROVIDE AND INSTALL A TWO (2) COAT CEMENTITIOUS PLASTER FINISH. FINISH SURFACE SHALL BE A TROWEL FINISH. TOTAL THICKNESS OF 3/8". INSTALL COVE AT INTERSECTION OF FOUNDATION WALLS AND FOOTINGS.
- VAPOR BARRIER: PROVIDE 6 MIL CARBONATED POLYETHYLENE FILM, RATED AT 0.1 PERMS.
- AIR INFILTRATION BARRIER: PROVIDE A 5 MIL HIGH DENSITY POLYETHYLENE FIBER AIR INFILTRATION BARRIER, "TYVEK" AS MANUFACTURED BY DUPONT OR APPROVED EQUAL WHERE INDICATED ON DRAWINGS.
- BUILDING INSULATION: PROVIDE MINERAL FIBER BLANKET INSULATION WITH 1.0 LB...DENSITY, K-0.27, THICKNESS AS INDICATED ON DRAWINGS. CONFORMING TO FS HH-I-521. PROVIDE TYPE III (REFLECTIVE ALUMINUM FOIL FACING) FOR ALL EXTERIOR WALLS AND CEILINGS, AND TYPE 1 FOR ALL INTERIOR APPLICATIONS.
- ASPHALT-FIBERGLASS SHINGLES: PROVIDE MINIMUM 235 LB. U.S. CLASS A, WIND-RESISTANT ASPHALT-FIBERGLASS SHINGLES. COLOR/TEXTURE/ PATTERN AS SELECTED BY OWNER UNLESS OTHERWISE NOTED.
- FLASHING AND SHEET METAL: PROVIDE ALUMINUM SHEET, 0.032", THICK C22A41 CLEAR ANODIZED FINISH FOR CONCEALED FLASHING LOCATIONS; AND 0.040" THICK C22A41 CLEAR ANODIZED FINISH FOR EXPOSED FLASHING LOCATIONS.
- PROVIDE METAL FLASHING OVER ALL WINDOWS AND DOORS IN EXTERIOR WALLS THROUGHOUT. PROVIDE PAN FLASHING UNDER ALL EXTERIOR DOORS. PROVIDE FLASHING WHERE CONCRETE IS IN CONTACT WITH WOOD FRAMING. ALL WALL FLASHING, BASE, CAP, THRU-WALL, AND/OR COUNTER-FLASHING, ETC., AS REQUIRED TO PREVENT THE ENTRANCE OF MOISTURE AND WATER.
- ATTIC VENTILATION: BASED ON INTERNATIONAL RESIDENTIAL CODE 2018, NEW JERSEY EDITION SECTION R806.2 , 1 SQ. FT. OF VENTILATION SHALL BE PROVIDED PER 150 SQ. FT. OF ATTIC AREA.
- GUTTERS AND DOWNSPOUTS: PROVIDE SEAMLESS ALUMINUM SHEET (0.032") GUTTERS AND DOWNSPOUTS AS SHOWN ON THE DRAWINGS. PROVIDE CONCRETE SPLASH BLOCKS AT ALL LEADERS. COLOR AS SELECTED BY OWNER
- **ROOFING SPECIALTIES: PROVIDE GABLE VENTS AND CONTINUOUS SOFFIT** VENTS WHERE INDICATED ON DRAWINGS.
- POWER VENTILATORS: PROVIDE ELECTRICAL POWERED THERMOSTATIC CONTROLLED ATTIC EXHAUST FAN WHERE INDICATED ON DRAWINGS.
- PROVIDE 2200 SUPER VENTER 1500 CFM AT 0.3 STATIC PRESSURE, AND MANUFACTURED BY D.P. SPECIALTIES, INC. AS INDICATED ON DRAWINGS.
- SEALANTS: ELASTOMERIC SEALANT SHALL BE 1 COMPONENT POLYSULFIDE OR 1 COMPONENT POLYURETHANE SEALANT CONFORMING TO FS TT-S-00230 CLASS A. PROVIDE CLOSED CELL SEALANT BACKER ROD. SUBMIT PRODUCT DATA TO ARCHITECT FOR APPROVAL.
- EXTERIOR JOINTS AROUND WINDOWS, DOORS, WALL AND FOUNDATION AND AROUND UTILITY SERVICE TO BE CAULKED, GASKETED, WEATHER-STRIPPED OR AS OTHERWISE NOTED.
- ENERGY CODE REQUIREMENTS: WALL INSULATION TO BE A MINIMUM OF R-13, AND CEILINGS A MINIMUM OF R-19 OR AS OTHERWISE DESIGNATED ON DRAWINGS FLOORS OVER UNHEATED SPACES TO BE A MINIMUM OF R-30.


- 8. DOORS AND WINDOWS
- WOOD DOORS: WHERE INDICATED ON DRAWINGS, PROVIDE DOORS WITH APPROPRIATE UL FIRE RESISTANCE RATING.
- EXTERIOR METAL CLAD DOORS: EXTERIOR METAL CLAD DOORS SHALL BE 1 3/4" THICK PRE-HUNG DOORS, THERMA-TRU OR EQUAL. GLASS LIGHTS SHALL BE 1/2" THICK TEMPERED INSULATING GLASS OF DIMENSIONS INDICATED ON DRAWINGS.
- VINYL WINDOWS: PROVIDE VINYL WINDOWS OF TYPES AND SIZES INDICATED ON DRAWINGS, WINDOWS SHALL BE PRE-GLAZED WITH DOUBLE PANE HIGH PERFORMANCE CLEAR FUSED INSULATING GLASS. BASIS OF DESIGN: ANDERSEN CORPORATION 200-SERIES OR APPROVED EQUAL.
- CODE REQUIREMENT: SLEEPING ROOM WINDOWS SPECIFIED SHALL COMPLY WITH SECTION R310 OF THE INTERNATIONAL RESIDENTIAL CODE 2018, NEW JERSEY EDITION CODE . A MINIMUM OF ONE OPERABLE WINDOW IN EACH BEDROOM SHALL HAVE A NET CLEAR OPENING OF FIVE AND SEVEN TENTHS (5.7) SQ. FT. THE MINIMUM NET CLEAR OPENING HEIGHT DIMENSION SHALL BE TWENTY FOUR (24") INCHES. THE MINIMUM NET CLEAR OPENING WIDTH DIMENSION SHALL BE TWENTY (20") INCHES.
- ALL GLAZING TO BE IN CONFORMANCE WITH SECTION R308 OF THE INTERNATIONAL RESIDENTIAL CODE 2018, NEW JERSEY EDITION.
- 9. <u>FINISHES</u>
- GYPSUM DRYWALL: PROVIDE 5/8" THICK STANDARD TAPER GYPSUM BOARD COMPLYING WITH ASTM C36 UNLESS OTHERWISE INDICATED. NAIL OR SCREW ATTACH DRYWALL TO WALL AND CEILING SYSTEMS. PROVIDE WATER-RESISTANT GYPSUM BOARD, (ASTM C630) IN TOILET ROOMS AND WET AREAS. PROVIDE MANUFACTURER'S STANDARD METAL TRIM ACCESSORIES OF THE BEAD TYPE. PROVIDE READY-MIXED VINYL JOINT COMPOUND AND PERFORATED JOINT TAPE. INSTALL COMPOUND IN THREE COATS.
- CLOSETS TO HAVE ONE SHELF AND ONE CLOTHES POLE UNLESS OTHERWISE NOTED. LINEN CLOSETS & PANTRIES TO HAVE FIVE (5) EVENLY SPACED SHELVES.
- 10. <u>SPECIALTIES</u>
- N/A
- 11. <u>EQUIPMENT</u>
- N/A
- 12. FURNISHINGS
- N/A
- 13. SPECIAL CONSTRUCTION
- N/A
- 14. CONVEYING SYSTEMS
- N/A
- 15. MECHANICAL
- THESE CONSTRUCTION DOCUMENTS DO NOT INCLUDE THE DESIGN OF PLUMBING, AIR CONDITIONING SYSTEMS. THE ARCHITECT ASSUMES NO RESPONSIBILITY FOR THEIR DESIGN. THE HVAC SUBCONTRACTOR SHALL DESIGN THE HEATING AND COOLING SYSTEM AND THE PLUMBING SUBCONTRACTOR SHALL DESIGN THE PLUMBING SYSTEM.
- PLUMBING SYSTEM: PROVIDE AND INSTALL ALL REQUIRED PIPING FOR THE SANITARY DRAINAGE, HOT AND COLD WATER SUPPLY AND NATURAL GAS SUPPLY. OBTAIN ALL REQUIRED PERMITS, INSPECTIONS AND APPROVALS. COORDINATE ALL WORK WITH THE GENERAL CONTRACTOR AND THE APPLICABLE UTILITY COMPANIES. THE ENTIRE INSTALLATION SHALL COMPLY WITH THE NATIONAL STANDARD PLUMBING CODE, STATE CODES AND LOCAL ORDINANCES AND THE LOCAL GAS COMPANY AND WATER COMPANY.
- HOT AND COLD WATER PIPING: ABOVE GROUND PIPING SHALL BE TYPE "L" COPPER. UNDERGROUND WATER SUPPLY LINE SHALL BE TYPE "K" COPPER OR SCHEDULED 40 PVC AND SHALL BE INSTALLED MINIMUM 48" BELOW FINISHED GRADE. INSULATE ALL HOT AND COLD WATER SUPPLY LINES LOCATED WITHIN THE BUILDING.
- SOIL AND WASTE PIPING SYSTEM: ALL WASTE PIPING UNDER CONCRETE SHALL BE SERVICE WEIGHT CAST IRON SOIL PIPE, SCHEDULE 40 PVC OR SCHEDULE 40 ABS. ALL ABOVE GROUND WASTE AND VENT PIPING SHALL BE SCHEDULE 40 PVC WITH DMV TYPE FITTINGS.
- NATURAL GAS PIPING: ALL ABOVE GROUND NATURAL GAS PIPING SHALL BE BLACK IRON OR GALVANIZED IRON. ALL UNDERGROUND NATURAL GAS PIPE SHALL BE GALVANIZED IRON PIPE.
- EXISTING SANITARY SEWER LINE: THE EXISTING SANITARY SEWER LINE MUST BE LOCATED AND CHECKED TO ESTABLISH ITS USABILITY BEFORE CONNECTING THE NEW PORTIONS OF THE SANITARY SEWER LINE INTO IT. IT MUST ALSO BE CLEANED OUT AS PART OF THE USABILITY TESTING. IF THE CONDITION OF THE EXISTING LINE IS GOOD, IT MAY BE USED. IF THE CONDITION IS QUESTIONABLE, IT MUST BE REPLACED. THE NEW PORTION OF THE SANITARY LINE SHALL BE SCHEDULE 40 PVC. IF THE EXISTING LINE MUST BE REPLACED, IT SHALL BE SCHEDULE 40 PVC.
- EXHAUST FANS: PROVIDE 50 CFM BATHROOM EXHAUST FANS WHERE SHOWN ON DRAWINGS. PROVIDE DUCT WORK AND ROOF JACKS IN ACCORDANCE WITH MANUFACTURER'S PRINTED INSTRUCTIONS TO VENT FAN THROUGH ROOF. USE INSULATED FLEX-DUCT TO PREVENT CONDENSATION.
- PROVIDE FRESH AIR INTAKE FROM THE EXTERIOR TO THE FURNACE FOR HEATING SYSTEMS AS REQUIRED.
- 16. ELECTRICAL
- THESE CONSTRUCTION DOCUMENTS DO NOT INCLUDE THE DESIGN OF ANY ELECTRICAL SYSTEMS. THE ARCHITECT ASSUMES NO RESPONSIBILITY FOR THEIR DESIGN. THE ELECTRICAL SUBCONTRACTOR SHALL DESIGN THE ELECTRICAL SYSTEM, USING WHAT IS CURRENTLY AVAILABLE AND UPGRADING TO MEET THE FOLLOWING STANDARDS.
- BASIC MATERIALS AND METHODS: PROVIDE AND INSTALL ALL REQUIRED WIRING FOR THE EXTERIOR ELECTRICAL SERVICE TO THE BUILDING. OBTAIN ALL REQUIRED PERMITS, INSPECTIONS AND APPROVALS. COORDINATE ALL WORK WITH THE GENERAL CONTRACTOR AND APPLICABLE UTILITY COMPANIES. THE ENTIRE INSTALLATION SHALL COMPLY WITH THE REQUIREMENTS OF THE 2014 NATIONAL ELECTRICAL CODE, STATE CODE, LOCAL ORDINANCES, THE LOCAL ELECTRIC UTILITY COMPANY AND THE TELEPHONE COMPANY.
- SMOKE AND CO2 DETECTOR SYSTEMS: PROVIDE AND INSTALL ALL SMOKE AND CO2 DETECTORS WITH AC PRIMARY POWER SOURCE AND SHALL RECEIVE POWER FROM A BATTERY WHEN THE AC PRIMARY POWER SOURCE IS INTERRUPTED. SMOKE AND CO2 DETECTORS SHALL BE UL APPROVED AND INSTALLED ACCORDING WITH SECTIONS R314 AND R315 OF THE INTERNATIONAL RESIDENTIAL CODE 2018, NEW JERSEY EDITION.



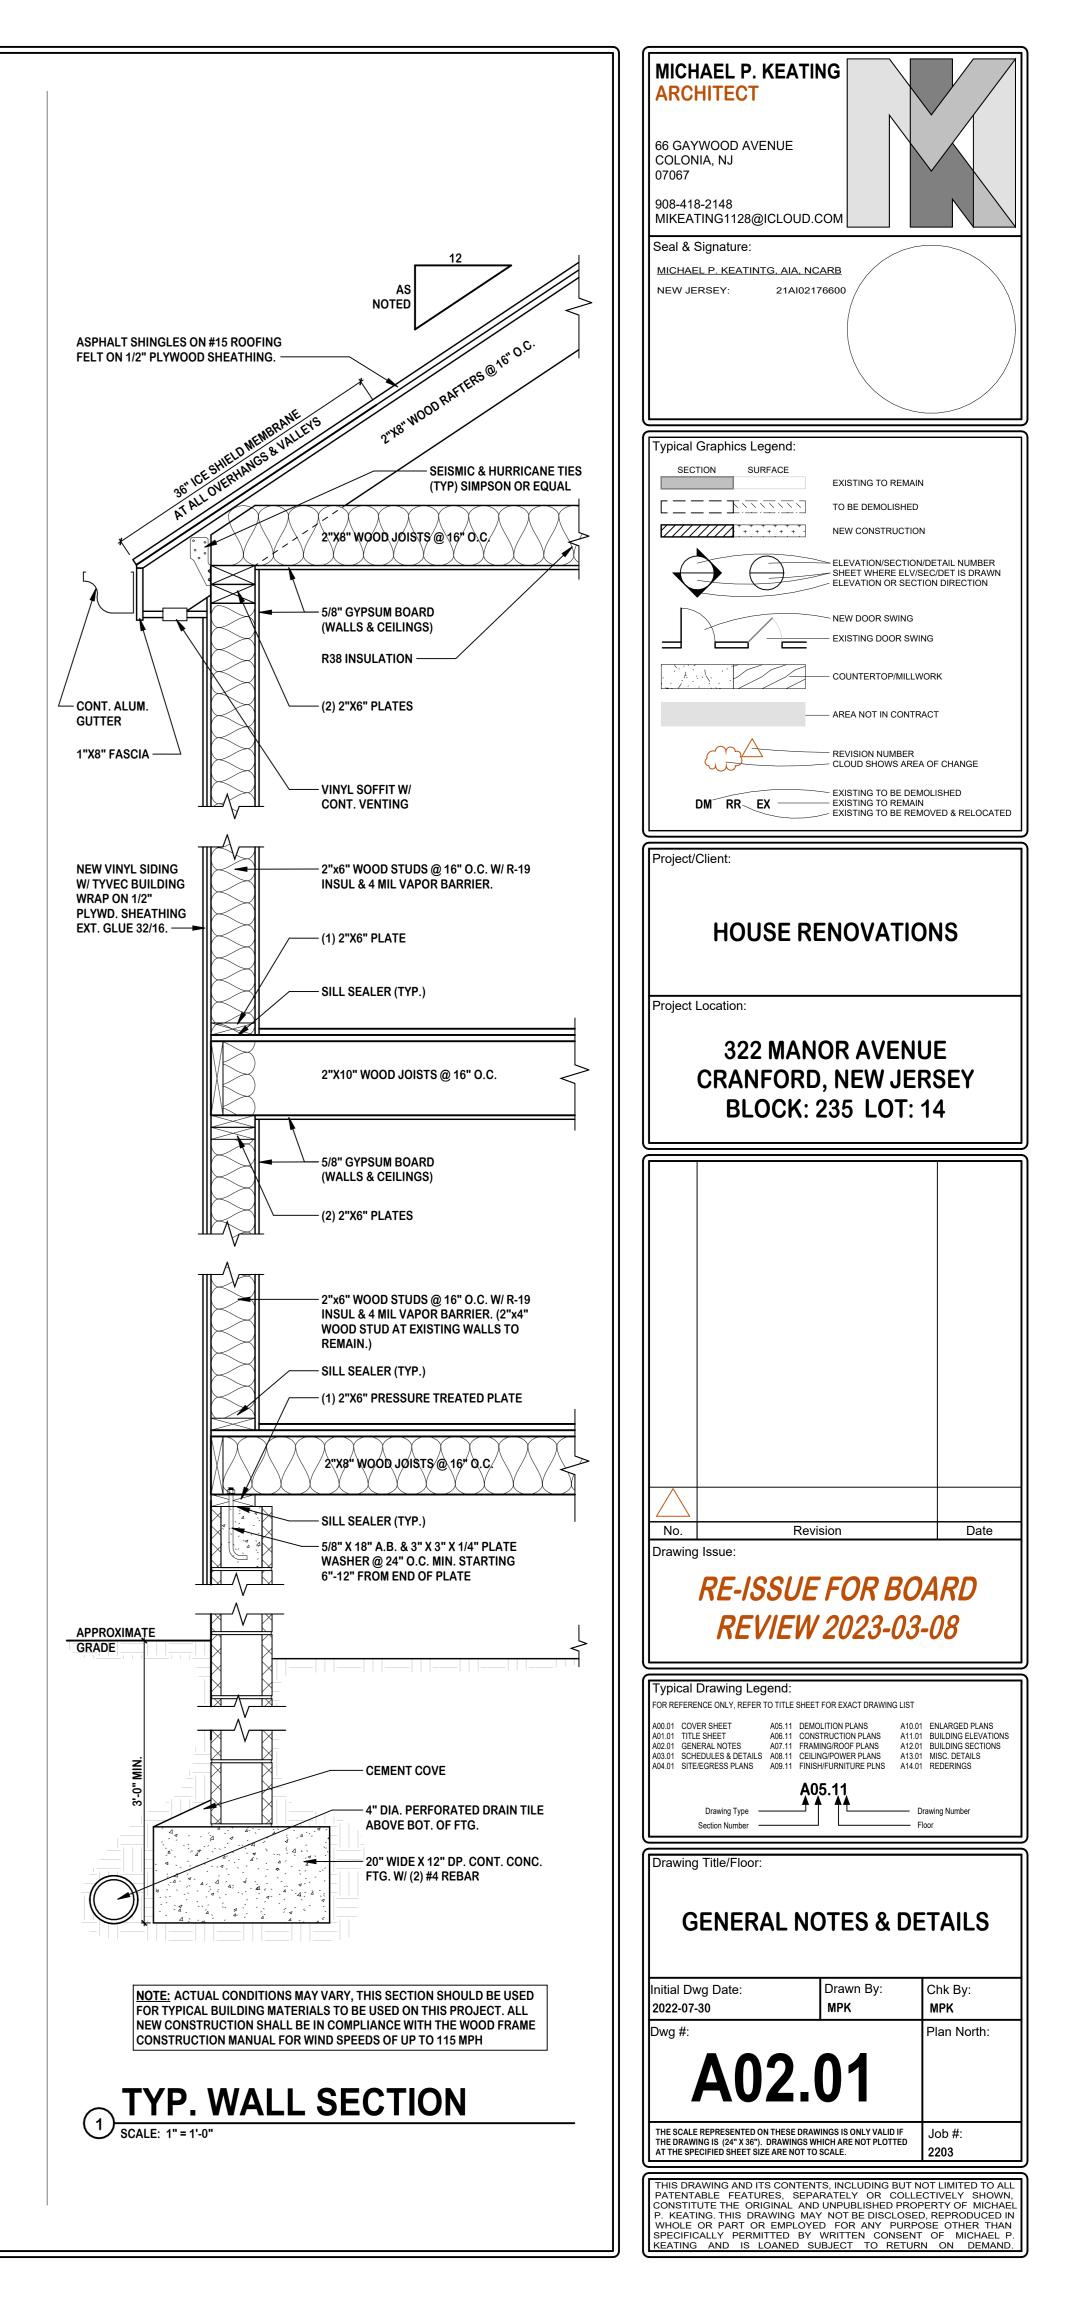

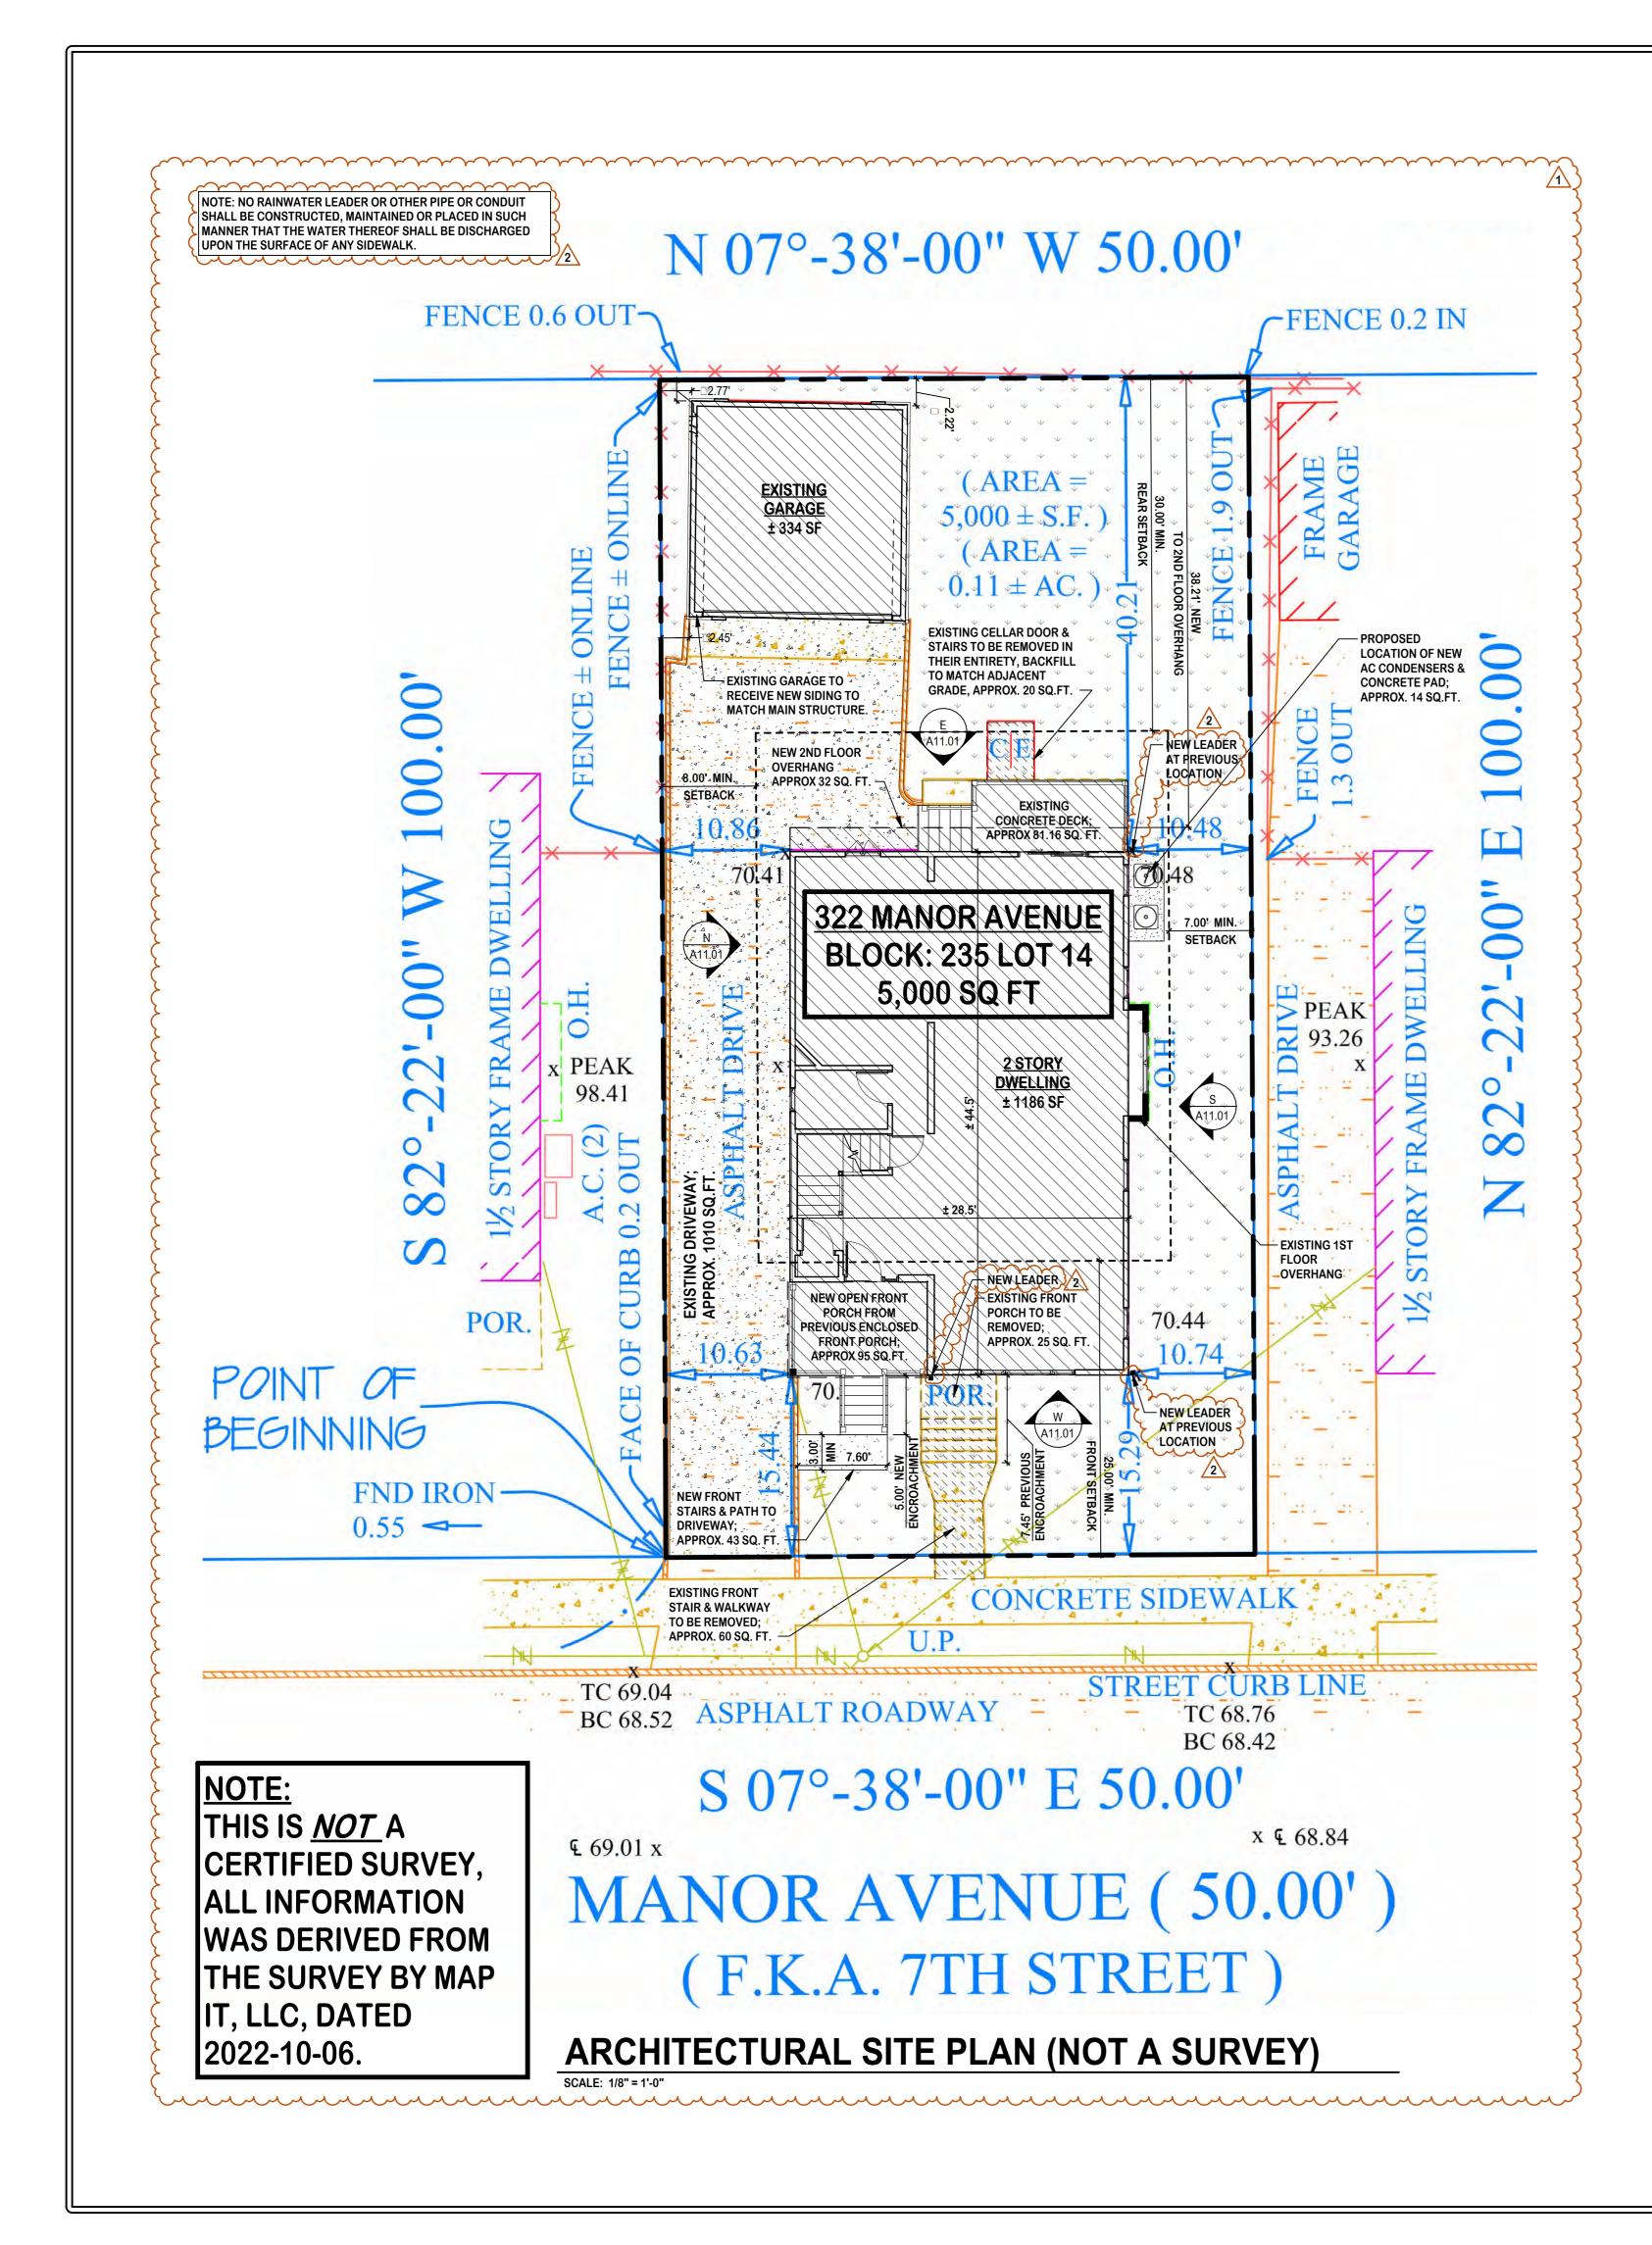	ALLOWABLE/ REQUIRED	EXISTING	
MIN. LOT AREA:	6,000 SF (MIN)	5,000 SF	
MIN. LOT WIDTH:	60 FT (MIN)	50 FT	
MIN. LOT DEPTH:	100 FT (MIN)	100.0 FT	
MIN. FRONT SETBACK:	25 FT (MIN)	15.29 FT	\sim
FRONT STAIR SETBACK ENCROACHMENT:	EXISTING OR NEW IN PREVIOUS LOCATION	<u>7.00 FT</u>	
MIN. REAR SETBACK:	30 FT (MIN) (SEE NOTE F)	40.21 FT	
MIN. SIDE SETBACKS: - TOTAL (BOTH) - RIGHT SIDE: - LEFT-SIDE:	15 FT (MIN) (30% WIDTH) 7 FT (MIN) (10% WIDTH OR 7 FT) 8 FT (MIN) (15 FT-7 FT)	21.37 FT 10.48 FT 10.63 FT	~~
MAX. LOT COVERAGE: (IMPERVIOUS SURFACES)	40% (MAX) 2.000 SQ.FT.	57.22% 2.861 SQ.FT.	
MAX. BUILDING COVERAGE:	<u>30% (MAX)</u> <u>1,500 SQ.FT.</u>	<u>34.25%</u> <u>1,709 SQ.FT.</u>	
MAX. BUILDING HEIGHT:	32.00 FT (MAX)	22.79 FT	
MAX. 1ST FLOOR HEIGHT FROM GROUND:	3.5 FT (MAX)	4.55 FT (HIGHEST) 4.33 FT (AVERAGE)	
MAX. BUILDING STORIES:	<u>2.5 STORIES (MAX)</u>	<u>2.5 STORIES</u>	
ACCESORY BUILDING - MAX. BUILDING HEIGHT: - MAX. BUILDING STORIES: - MIN. SIDE SETBACK: - MIN. REAR SETBACK:	16 FT (MAX) 1 (MAX) 10 FT (MIN) 10 FT (MIN)	13 FT 1 1 2.45 FT 1.77 FT	
FOOTNOTE 1:	SCHEDULE 1 - NOTE F: 30% OF THE FIRST 100 FT OF LOT D	EPTH; 45% OF THE NEXT 50 FT OF LO	OT DEP
FOOTNOTE 2:	NONCONFORMING SETBACKS. WH MAY BE EXPANDED, PROVIDED THA	ERE A LOT EXISTS IN SINGLE OWNER AT EXISTING NONCONFORMING YAR	DS OR
FOOTNOTE 3:	GRADE WHERE THE BASEMENT OR	A PORTION THEREOF EXTENDS ABO	OVE TH
FOOTNOTE 4:	D(3) UNCOVERED STEPS ONLY MAY	PROJECT UP TO FIVE FEET INTO A	
	MIN. LOT WIDTH: MIN. LOT DEPTH: MIN. FRONT SETBACK: FRONT STAIR SETBACK ENCROACHMENT: MIN. REAR SETBACKS: - TOTAL (BOTH) - RIGHT SIDE: - LEFT SIDE: - LEFT SIDE: MAX. BUILDING COVERAGE: MAX. BUILDING HEIGHT: MAX. BUILDING HEIGHT FROM GROUND: MAX. BUILDING STORIES: - MAX. BUILDING STORIES: - MAX. BUILDING STORIES: - MIN. SIDE SETBACK: - MIN. REAR SETBACK:	REQUIRED MIN. LOT AREA: 6,000 SF (MIN) MIN. LOT WIDTH: 60 FT (MIN) MIN. LOT DEPTH: 100 FT (MIN) MIN. FRONT SETBACK: 25 FT (MIN) FRONT SETBACK: 20 FT (MIN) MIN. REAR SETBACK: 30 FT (MIN) (30% WIDTH) FIGHT SIDE: 15 FT (MIN) (30% WIDTH) - TOTAL (BOTH) 15 FT (MIN) (30% WIDTH) - RIGHT SIDE: 7 FT (MIN) (10% WIDTH OR 7 FT) - LEFT SUBE 2,000 SQ.FT. MAX. LOT COVERAGE: 40% (MAX) (IMPERVIOUS SURFACES) 2,000 SQ.FT. MAX. BUILDING HEIGHT: 32.00 FT (MAX) MAX. BUILDING HEIGHT 3.5 FT (MAX) MAX. BUILDING HEIGHT: 16 FT (MAX) MAX. BUILDING STORIES: 2.5 STORIES (MAX) - MAX. BUILDING STORIES: 10 FT (MIN) - MAX. BUILDING STORIES: 10 FT (MIN) - MAX. BUILDING HEIGHT: 16 FT (MAX) - MAX. BUILDING STORIES: 10 FT (MIN) <	REQUIRED EAUSTING MIN. LOT AREA: 6,000 SF (MIN) 5,000 SF MIN. LOT WIDTH: 60 FT (MIN) 50 FT MIN. LOT WIDTH: 60 FT (MIN) 100.0 FT MIN. LOT DEPTH: 100 FT (MIN) 100.0 FT MIN. FRONT SETBACK: 25 FT (MIN) 15.29 FT MIN. REAR SETBACK: EXISTING OR NEW IN PREVIOUS LOCATIONS Z00 FT MIN. REAR SETBACK: EXISTING OR NEW IN PREVIOUS LOCATIONS Z00 FT MIN. REAR SETBACK: EXISTING OR NEW IN PREVIOUS LOCATIONS Z00 FT MIN. REAR SETBACK: 55 FT (MIN) (30% WIDTH) 7 FT (MIN) (10% WIDTH OR 7 FT) 21.37 FT OTAL (BOTH) 7 FT (MIN) (10% WIDTH OR 7 FT) 10.48 FT ALLOCATION (MAX) 2.65 SQ.FT. 2.86 SQ.FT. MAX. LOT COVERAGE: 30% (MAX) 2.45% MAX. BUILDING COVERAGE. 30% (MAX) 2.45 ST CH(HIGHEST) MAX. BUILDING HEIGHT: 3.5 FT (MAX) 4.35 FT (HIGHEST) AX. BUILDING HEIGHT: 3.5 FT (MAX) 13 FT (A MAX. BUILDING STORIES: 1 6 FT (MAX) 13 FT (A MAX. BUILDING STORIES: 16 FT




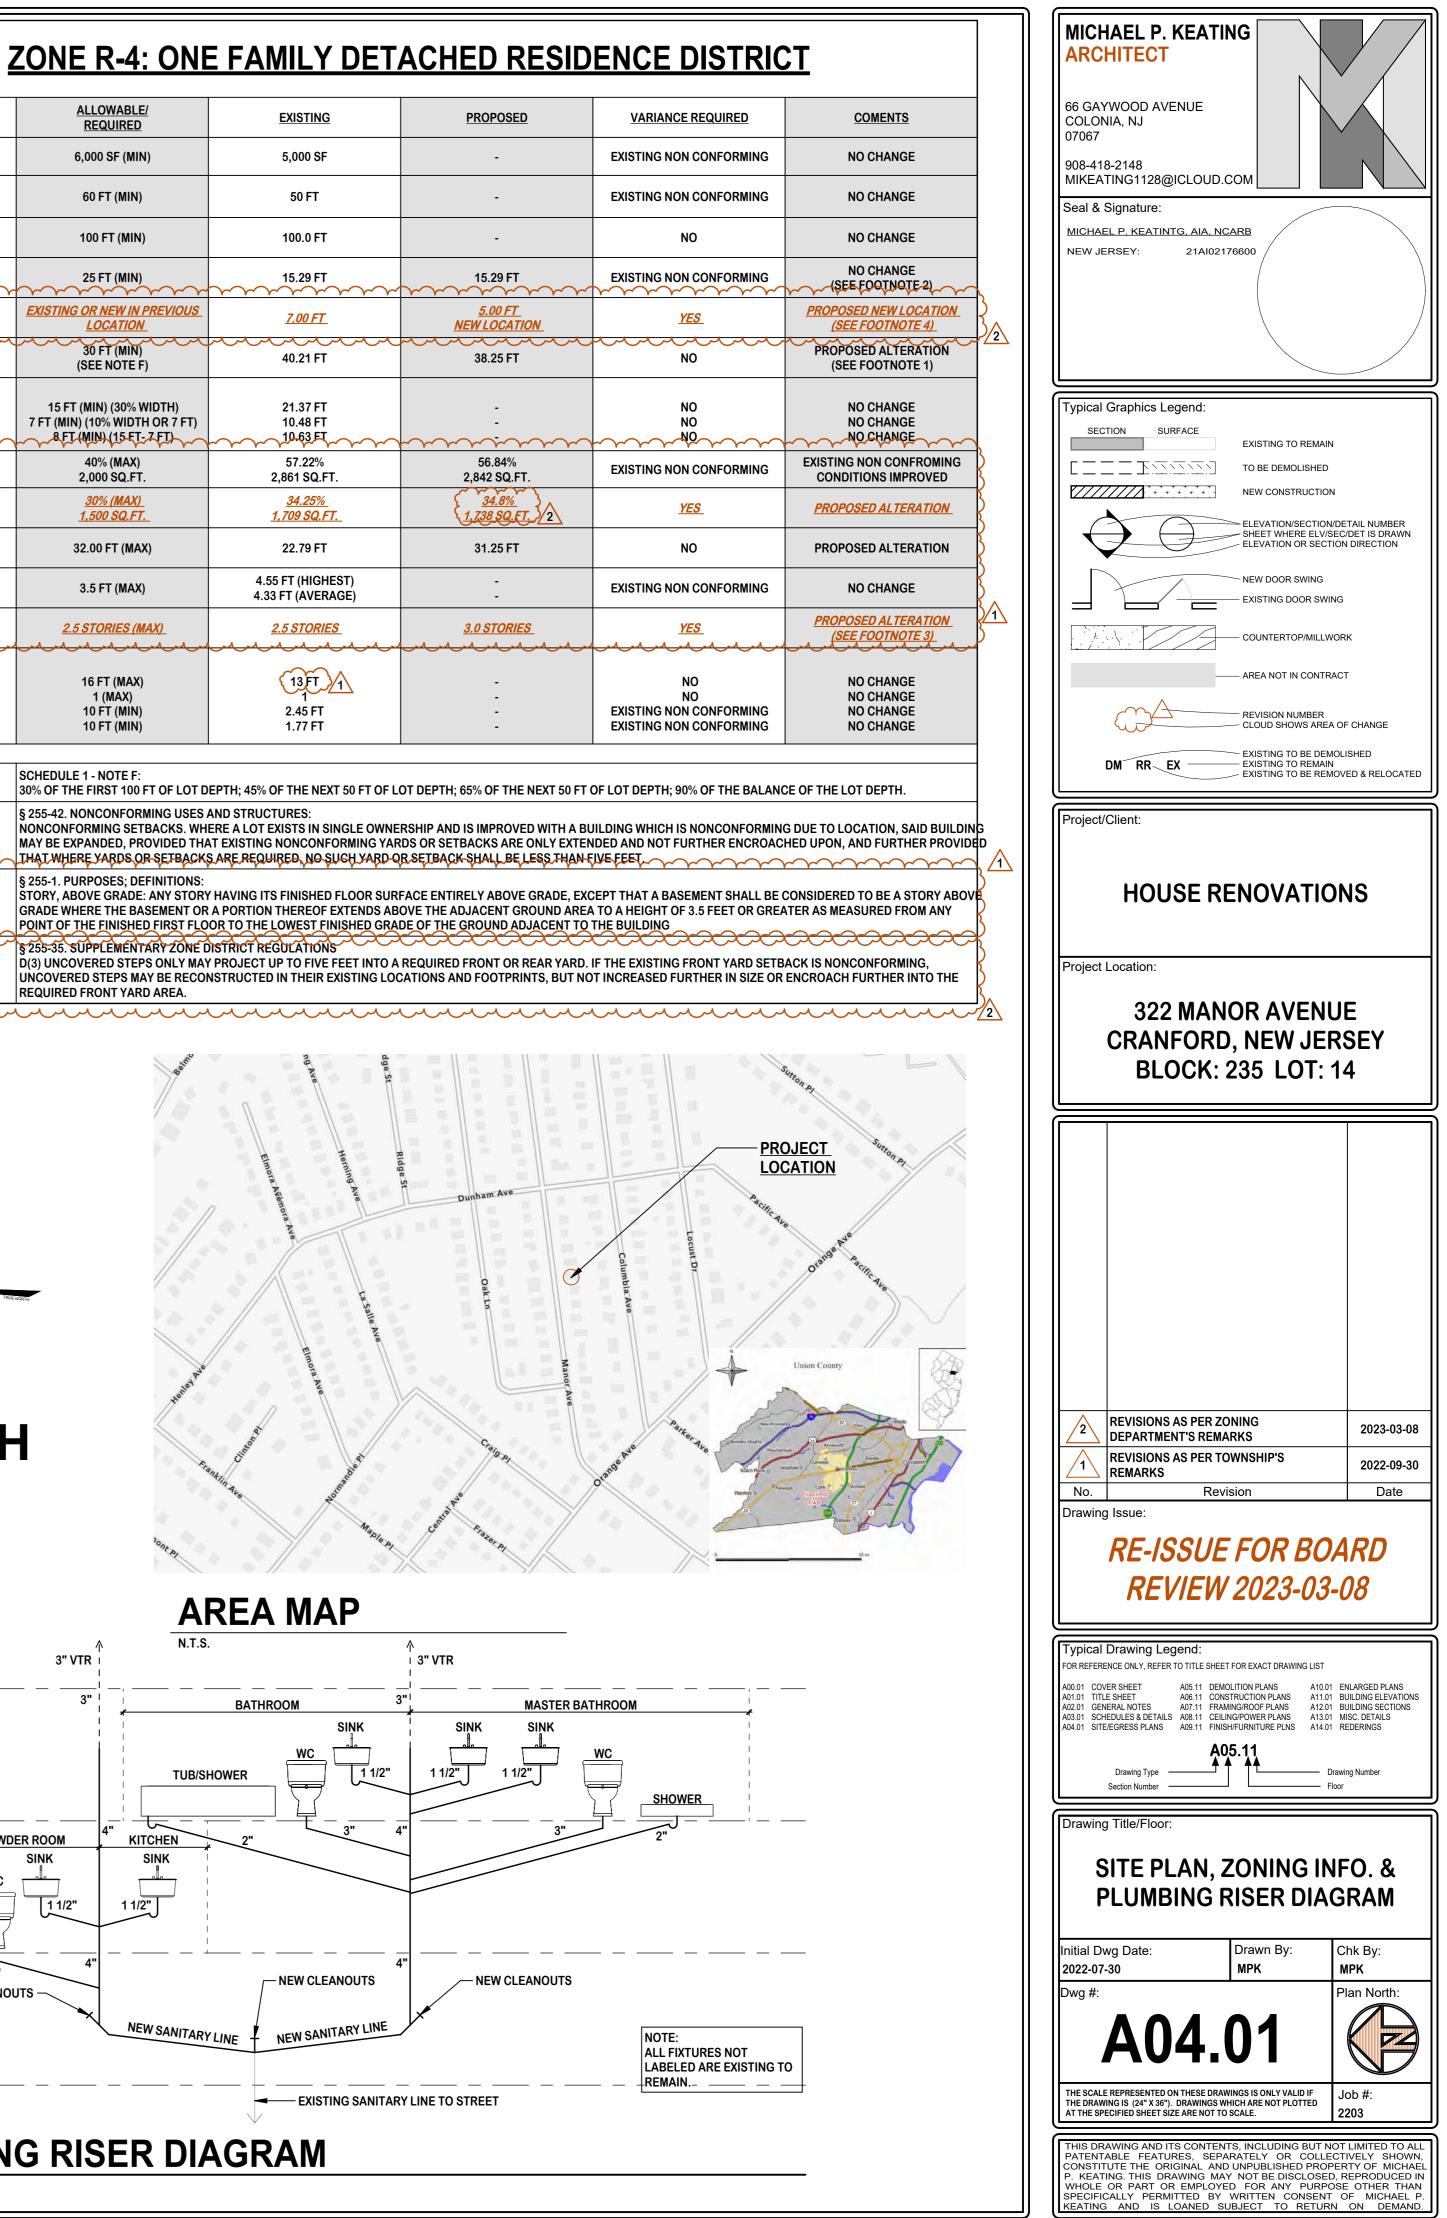



3" VTR i 2ND FLOOR POWDER ROOM **KITCHEN** 1ST FLOOR NEW CLEANOUTS NEW SANITARY LINE

PLUMBING RISER DIAGRAM

SCALE: 1/4" = 1'-0"

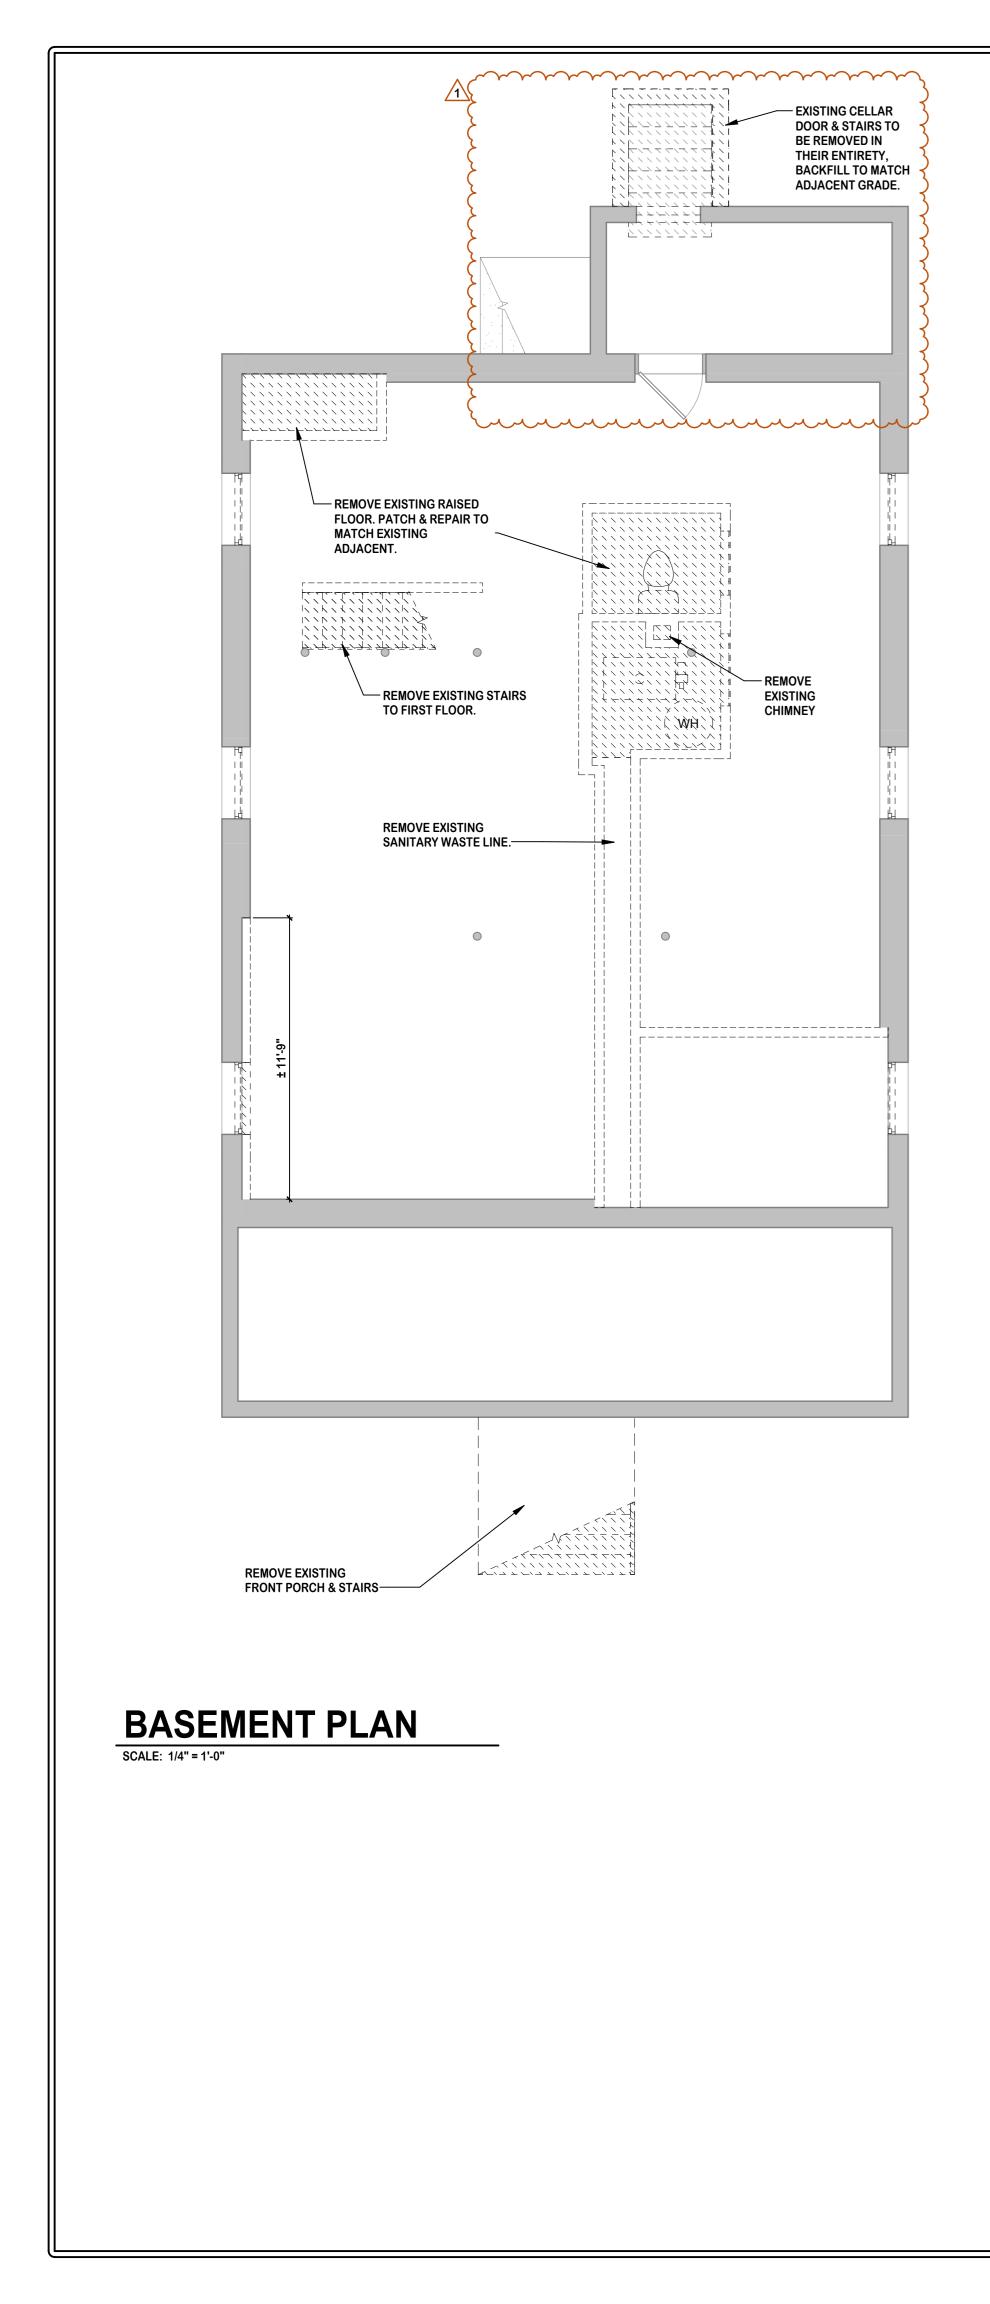

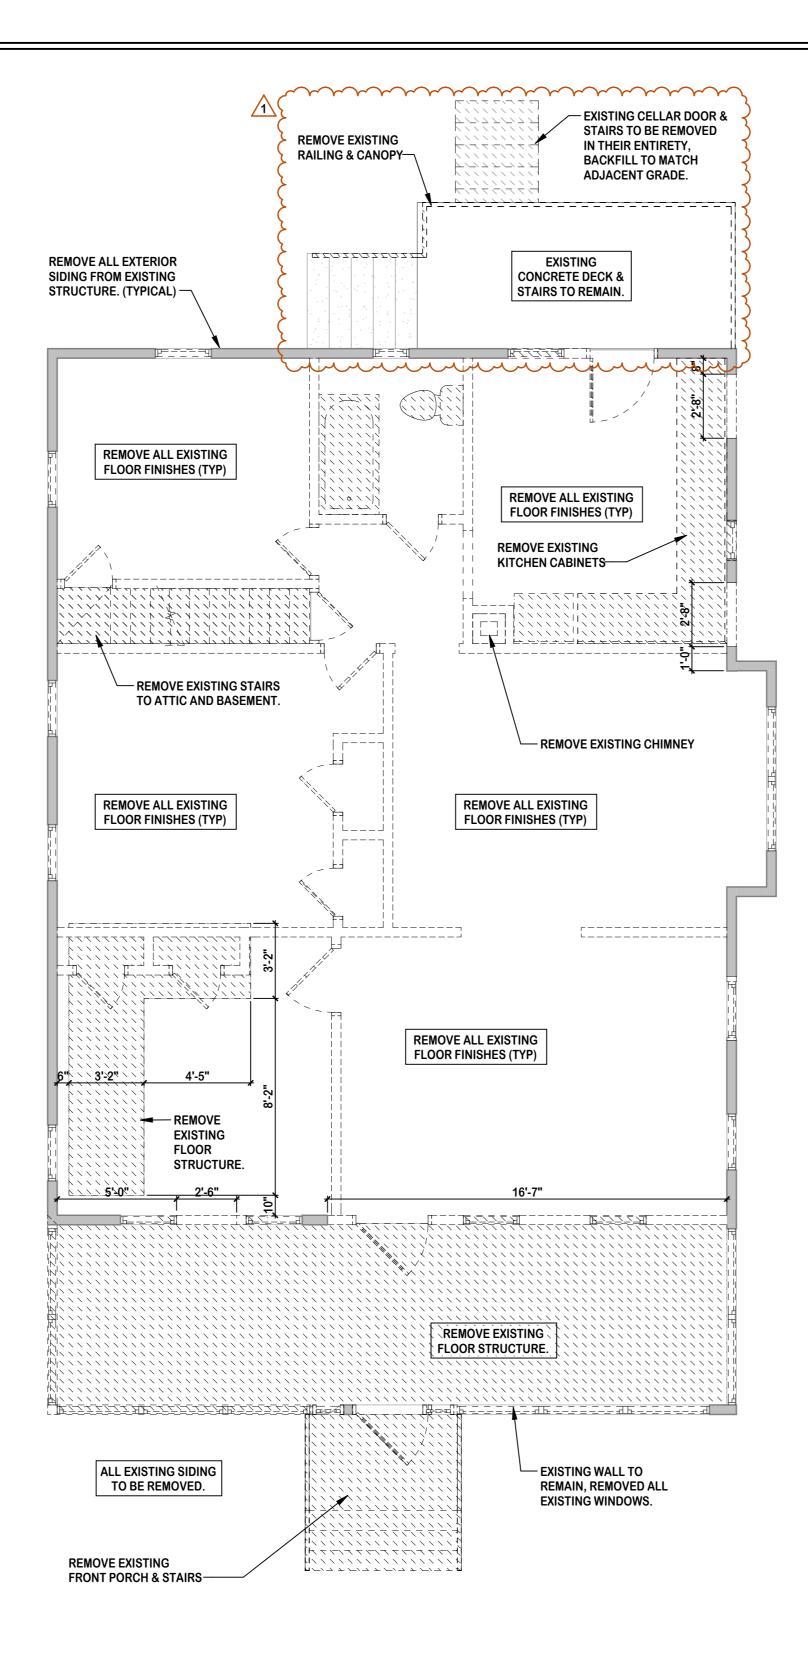

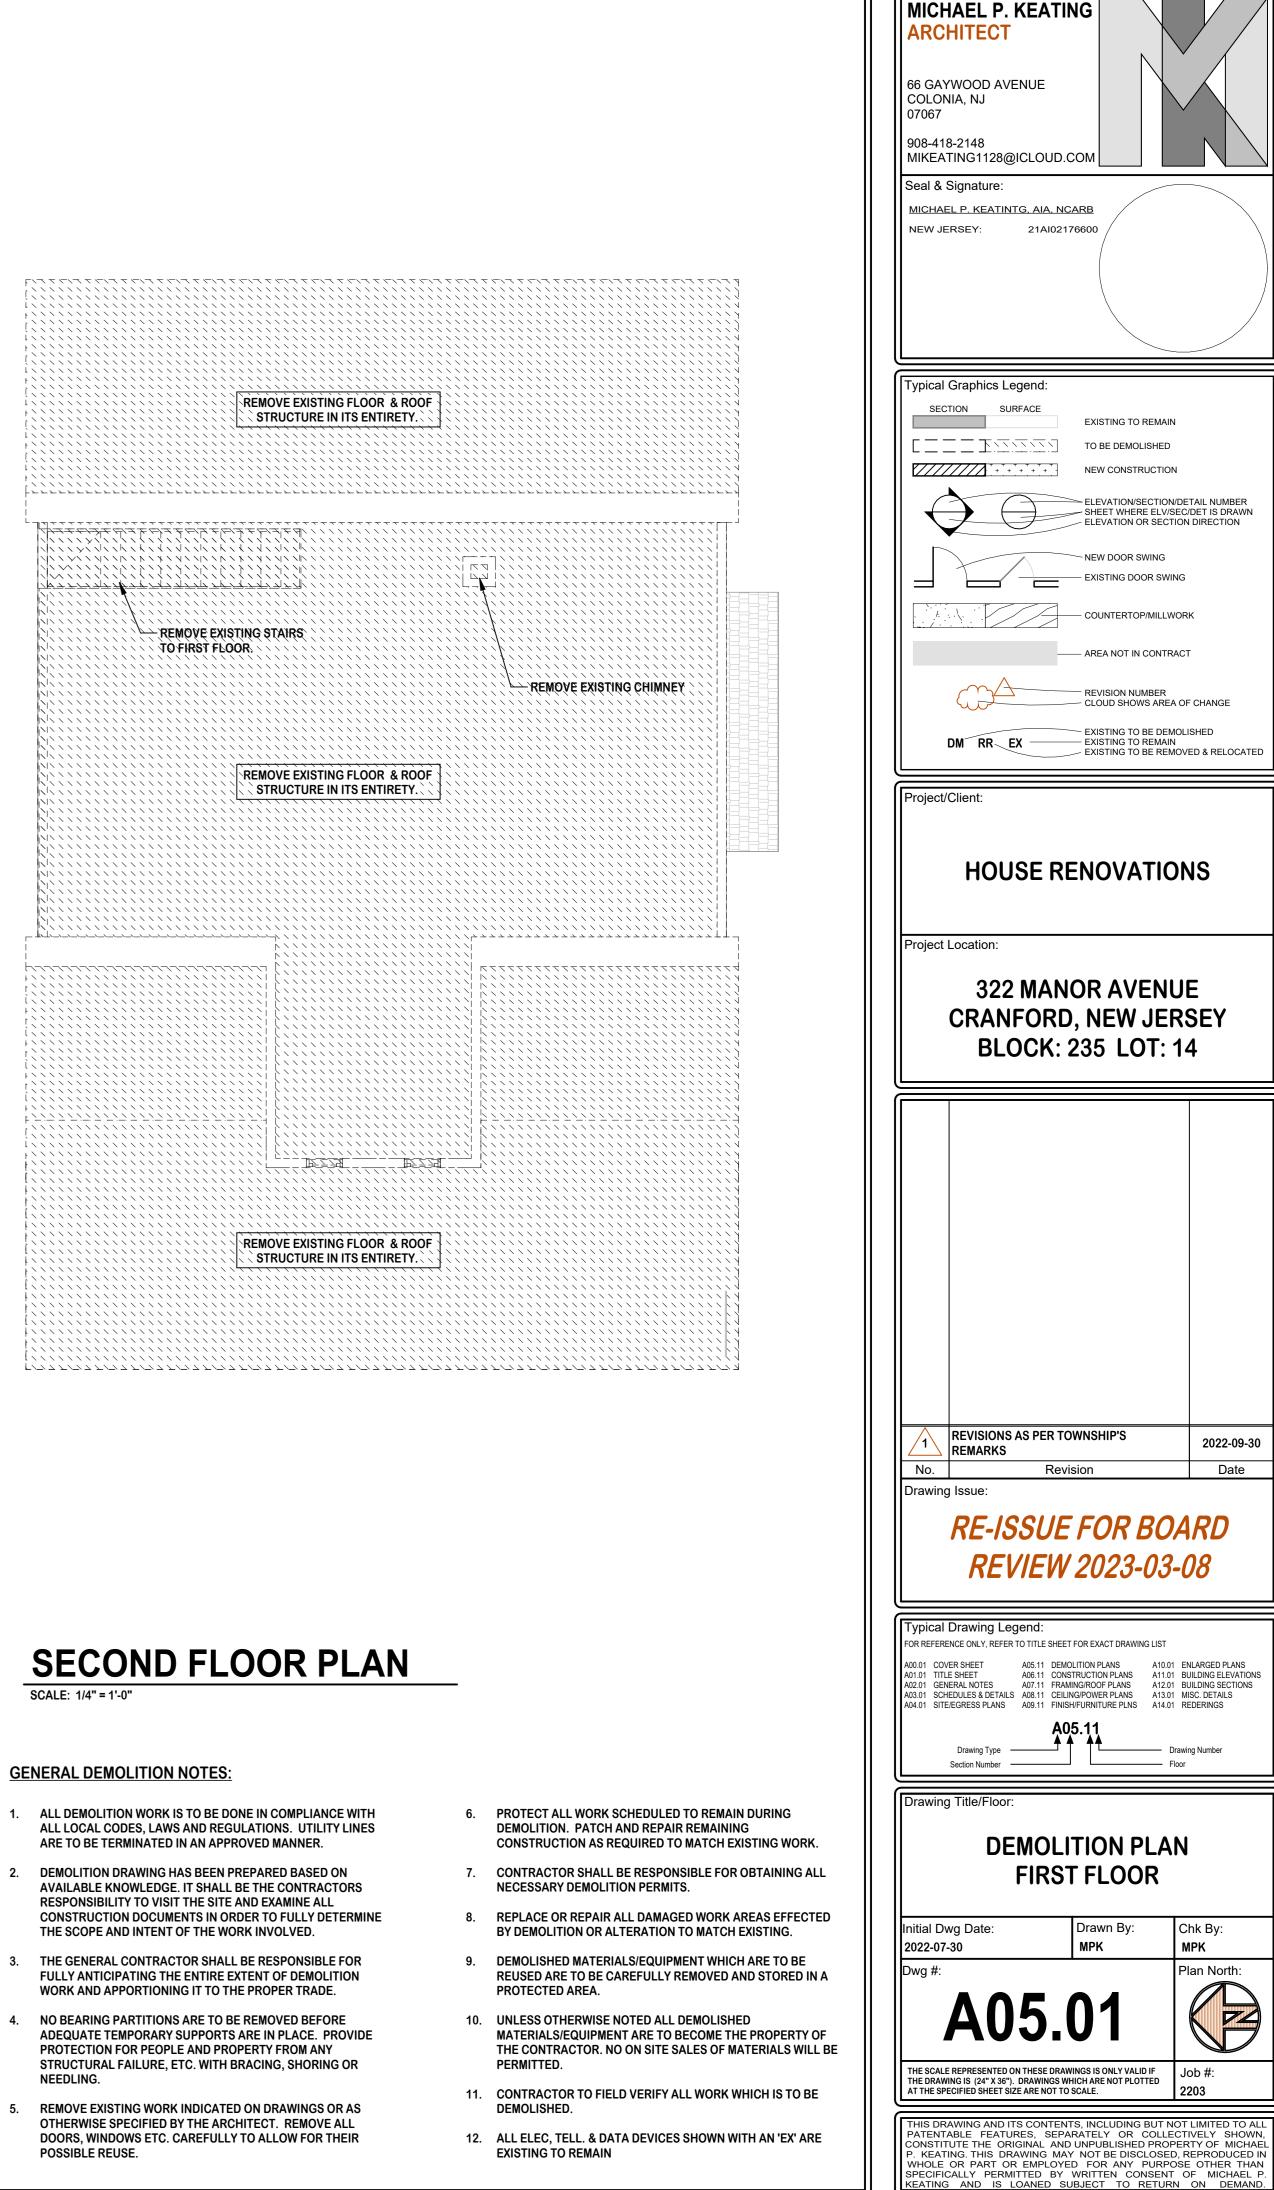

FISRT FLOOR PLAN

SCALE: 1/4" = 1'-0"

DEMOLITION PLAN LEGEND:


- EXISTING TO REMAIN (CUT)
 - EXISTING TO REMAIN (SURFACE)
- $\Box \equiv \Xi \equiv \Box$ EXISTING TO BE DEMOLISHED (CUT)
- ∇ EXISTING TO BE DEMOLISHED (SURFACE)
- $\sim \sim \sim \sim \sim \sim$ **REMOVE EXISTING FINISH FROM EXISTING WALL TO REMAIN & PREPARE SURFACE TO RECEIVE NEW**
 - REMOVE DOOR, DOOR FRAME, AND DOOR
 - HARDWARE.
- REMOVE AND RELOCATE RR

FINISH

DEMOLISH

RW

EXISTING TO REMAIN FX

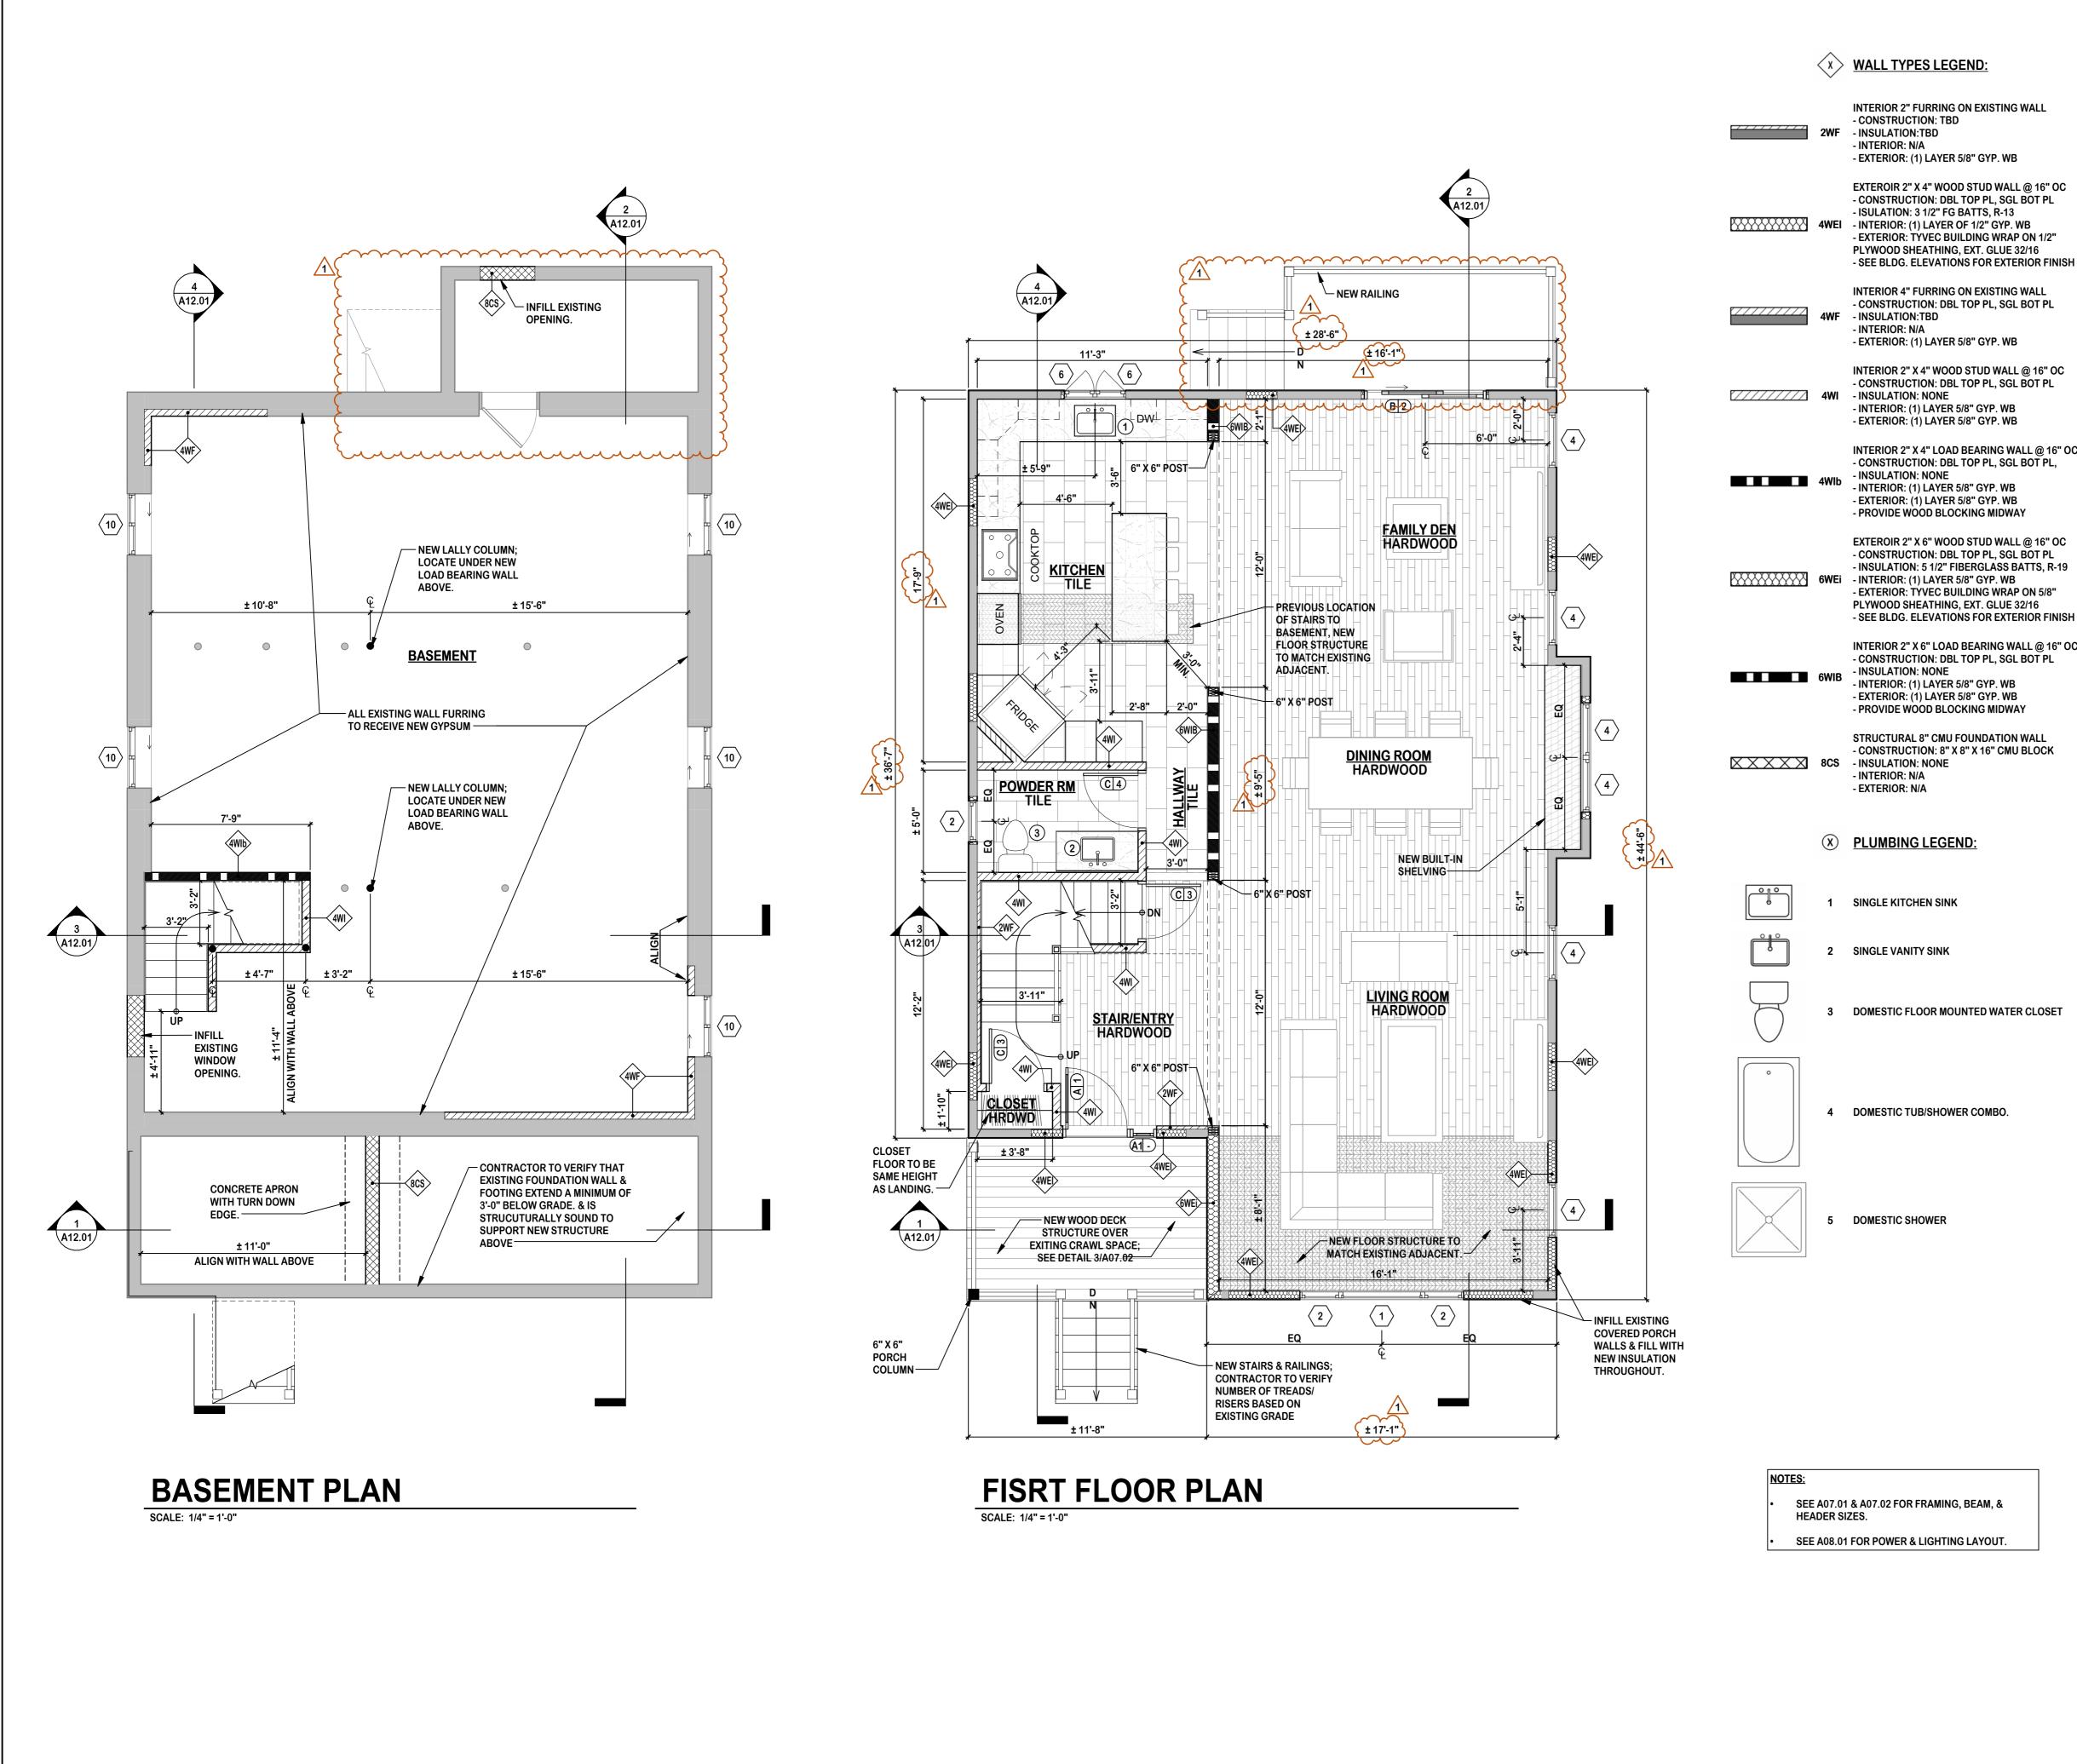



- INTERIOR 2" FURRING ON EXISTING WALL
- EXTERIOR: (1) LAYER 5/8" GYP. WB
- EXTEROIR 2" X 4" WOOD STUD WALL @ 16" OC - CONSTRUCTION: DBL TOP PL, SGL BOT PL - ISULATION: 3 1/2" FG BATTS, R-13 - EXTERIOR: TYVEC BUILDING WRAP ON 1/2" PLYWOOD SHEATHING, EXT. GLUE 32/16 - SEE BLDG. ELEVATIONS FOR EXTERIOR FINISH
- **INTERIOR 4" FURRING ON EXISTING WALL** - CONSTRUCTION: DBL TOP PL, SGL BOT PL
- EXTERIOR: (1) LAYER 5/8" GYP. WB
- INTERIOR 2" X 4" WOOD STUD WALL @ 16" OC - CONSTRUCTION: DBL TOP PL, SGL BOT PL - INTERIOR: (1) LAYER 5/8" GYP. WB
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- INTERIOR 2" X 4" LOAD BEARING WALL @ 16" OC - CONSTRUCTION: DBL TOP PL, SGL BOT PL,
- PROVIDE WOOD BLOCKING MIDWAY EXTEROIR 2" X 6" WOOD STUD WALL @ 16" OC
- INSULATION: 5 1/2" FIBERGLASS BATTS, R-19 - EXTERIOR: TYVEC BUILDING WRAP ON 5/8" PLYWOOD SHEATHING, EXT. GLUE 32/16
- INTERIOR 2" X 6" LOAD BEARING WALL @ 16" OC - CONSTRUCTION: DBL TOP PL, SGL BOT PL - EXTERIOR: (1) LAYER 5/8" GYP. WB
- PROVIDE WOOD BLOCKING MIDWAY
- STRUCTURAL 8" CMU FOUNDATION WALL - CONSTRUCTION: 8" X 8" X 16" CMU BLOCK
- DOMESTIC FLOOR MOUNTED WATER CLOSET
- DOMESTIC TUB/SHOWER COMBO.

- $\langle x \rangle$ <u>WINDOW LEGEND:</u>
- 1 4'-0" W X 4'-0" H FIXED PICTURE WINDOW - FINISH: TBD - GLAZING: CLEAR
- 2 2'-0" W X 4'-0" H DOUBLE HUNG WINDOW - FINISH: TBD - GLAZING: CLEAR
- 3 3'-0" W X 4'-9" H DOUBLE HUNG WINDOW - FINISH: TBD - GLAZING: CLEAR
- 4 2'-8" W X 4'-0" H DOUBLE HUNG WINDOW - FINISH: TBD - GLAZING: CLEAR
- 5 3'-0" W X 4'-0" H FIXED PICTURE WINDOW - FINISH: TBD - GLAZING: CLEAR
- 6 1'-6" W X 3'-0" H CASEMENT WINDOW - FINISH: TBD - GLAZING: CLEAR
- 7 6'-0" W X 5'-0" H FIXED PICTURE WINDOW - FINISH: TBD - GLAZING: CLEAR
- 8 1'-6" W X 3'-0" H DOUBLE HUNG WINDOW - FINISH: TBD - GLAZING: CLEAR
- 9 3'-0" W X 2'-0" H DOUBLE SLIDING WINDOW - FINISH: TBD - GLAZING: CLEAR
- 10 3'-0" W X 1'-6" H DOUBLE SLIDING WINDOW - FINISH: TBD - GLAZING: CLEAR

X DOOR TYPES LEGEND:

- A 3'-0" W X 6'-8" H SINGLE HINGE ENTRY DOOR - APPLICATION: EXTERIOR - FIRE RATING: NONE - STYLE: 3 PANEL W/ 1/4 GLASS INLAY - FINISH: TBD - GLAZING: CLEAR
- A1 1'-0" W X 6'-8" H SIDE LITE - APPLICATION: EXTERIOR - FIRE RATING: NONE - STYLE: 1 PANEL W/ FULL GLASS INLAY - FINISH: TBD - GLAZING: CLEAR
- B 5'-8" W X 6'-8" H TWO LEAF SLIDING DOOR - APPLICATION: EXTERIOR - FIRE RATING: NONE - STYLE: 1 PANEL, FULL GLASS - FINISH: TBD - GLAZING: CLEAR
- C 2'-8" W X 6'-8" H SGL HINGE DOOR - APPLICATION: INTERIOR - FIRE RATING: NONE - STYLE: 6 PANEL - FINISH: TBD
- D 5'-8" W X 6'-8" H FOUR LEAF FOLDING DOOR - APPLICATION: INTERIOR - FIRE RATING: NONE
- STYLE: 3 PANEL, HORIZONTAL - FINISH: TBD E 2'-6" W X 6'-8" H TWO LEAF FOLDING DOOR
- APPLICATION: INTERIOR - FIRE RATING: NONE - STYLE: 3 PANEL, HORIZONTAL - FINISH: TBD
- F 2'-2" W X 4'-6" H ATTIC ACCESS STAIRS
- **DOOR HARDWARE LEGEND:**
- 1 EXTERIOR GRADE LATCH: - TYPE: BUILDING ENTRY - LOCKSET: LOCKABEL WITH DEADBOLT - FINISH: TBD
- 2 EXTERIOR GRADE SLIDING DOOR LATCH: - TYPE: BUILDING ENTRY - LOCKSET: LOCKABEL WITH DEADBOLT - FINISH: TBD
- 3 INTERIOR GRADE KNOB: - TYPE: HALL/CLOSET - LOCK: NONE - FINISH: TBD
- 4 INTERIOR GRADE KNOB: - TYPE: BEDRROM/BATHROOM - LOCK: LOCKABLE - FINISH: TBD
- 5 TYPICAL BI-FOLD DOOR HARDWARE: - TYPE: STANDARD - LOCK: NONE - FINISH: TBD

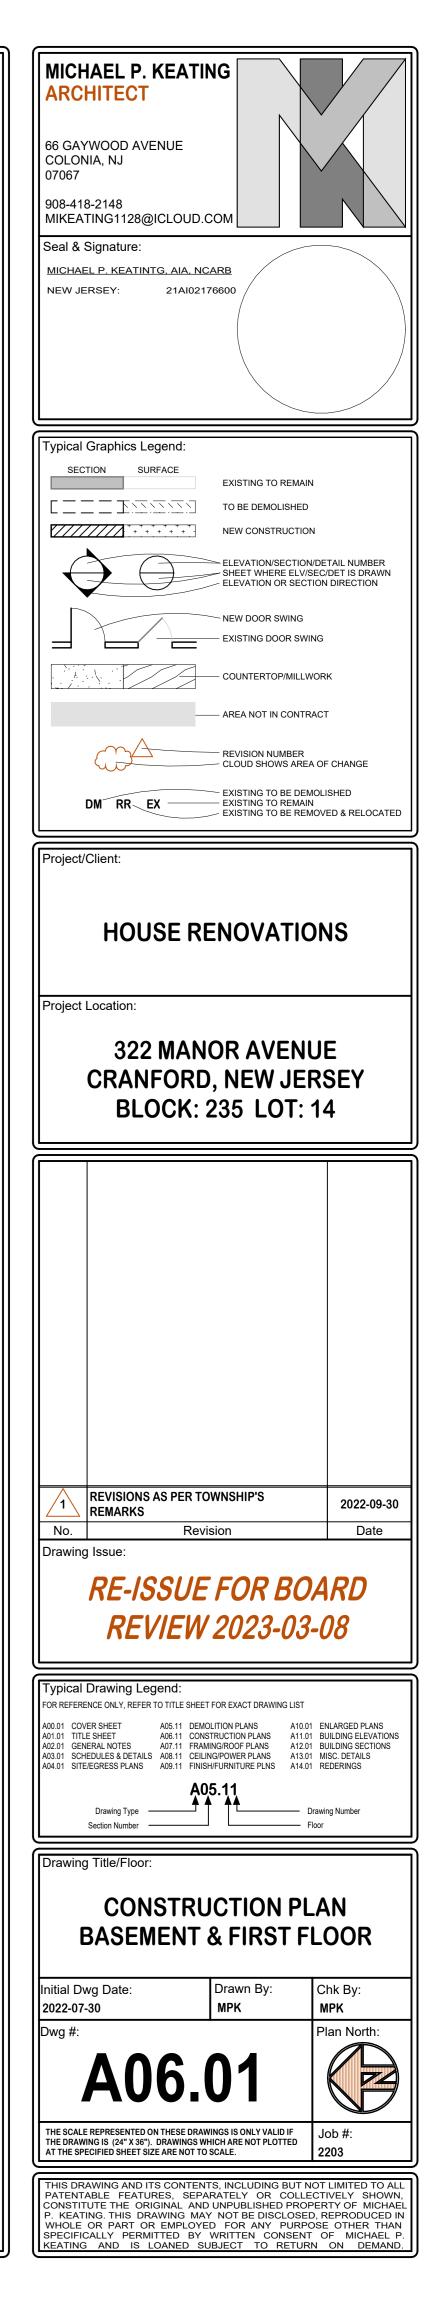

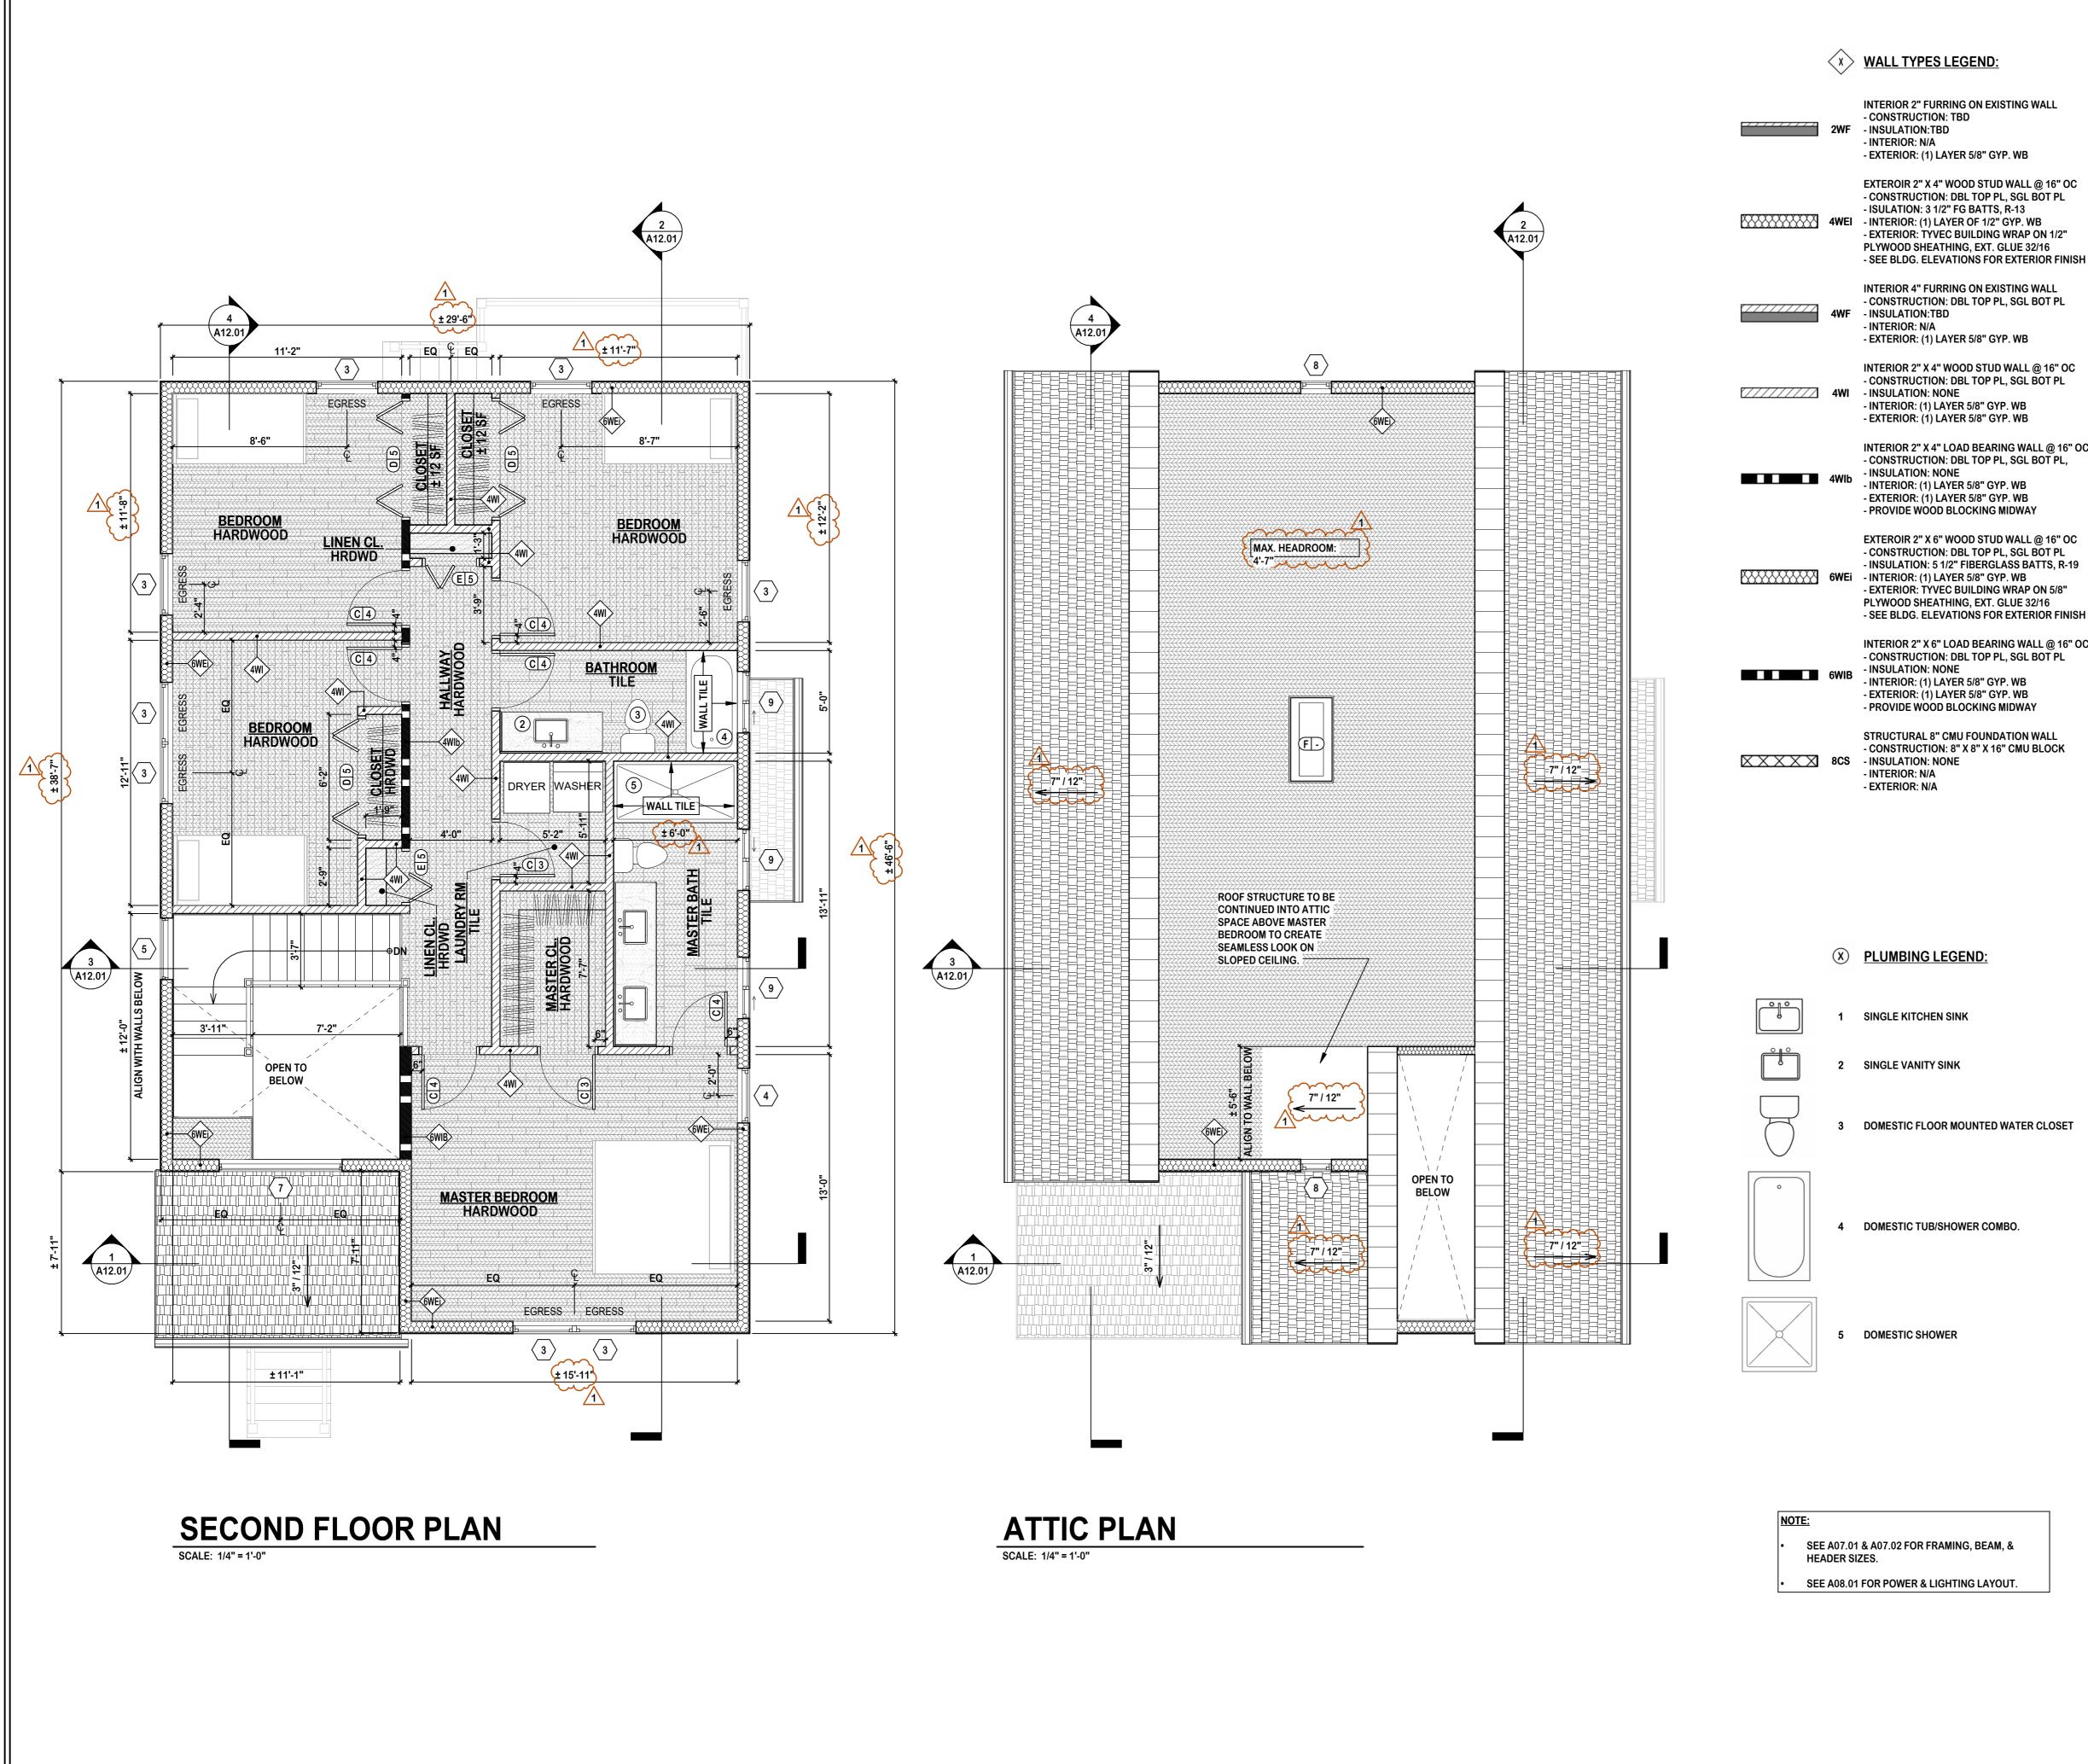

- INTERIOR 2" FURRING ON EXISTING WALL
- EXTERIOR: (1) LAYER 5/8" GYP. WB
- EXTEROIR 2" X 4" WOOD STUD WALL @ 16" OC - CONSTRUCTION: DBL TOP PL, SGL BOT PL - ISULATION: 3 1/2" FG BATTS, R-13 - EXTERIOR: TYVEC BUILDING WRAP ON 1/2" PLYWOOD SHEATHING, EXT. GLUE 32/16 - SEE BLDG. ELEVATIONS FOR EXTERIOR FINISH
- **INTERIOR 4" FURRING ON EXISTING WALL** - CONSTRUCTION: DBL TOP PL, SGL BOT PL
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- INTERIOR 2" X 4" WOOD STUD WALL @ 16" OC - CONSTRUCTION: DBL TOP PL, SGL BOT PL - INTERIOR: (1) LAYER 5/8" GYP. WB
- EXTERIOR: (1) LAYER 5/8" GYP. WB
- INTERIOR 2" X 4" LOAD BEARING WALL @ 16" OC - CONSTRUCTION: DBL TOP PL, SGL BOT PL,
- PROVIDE WOOD BLOCKING MIDWAY
- CONSTRUCTION: DBL TOP PL, SGL BOT PL - INSULATION: 5 1/2" FIBERGLASS BATTS, R-19 - EXTERIOR: TYVEC BUILDING WRAP ON 5/8" PLYWOOD SHEATHING, EXT. GLUE 32/16
- INTERIOR 2" X 6" LOAD BEARING WALL @ 16" OC - CONSTRUCTION: DBL TOP PL, SGL BOT PL - INTERIOR: (1) LAYER 5/8" GYP. WB - EXTERIOR: (1) LAYER 5/8" GYP. WB
- PROVIDE WOOD BLOCKING MIDWAY
- STRUCTURAL 8" CMU FOUNDATION WALL - CONSTRUCTION: 8" X 8" X 16" CMU BLOCK

- DOMESTIC FLOOR MOUNTED WATER CLOSET
- DOMESTIC TUB/SHOWER COMBO.


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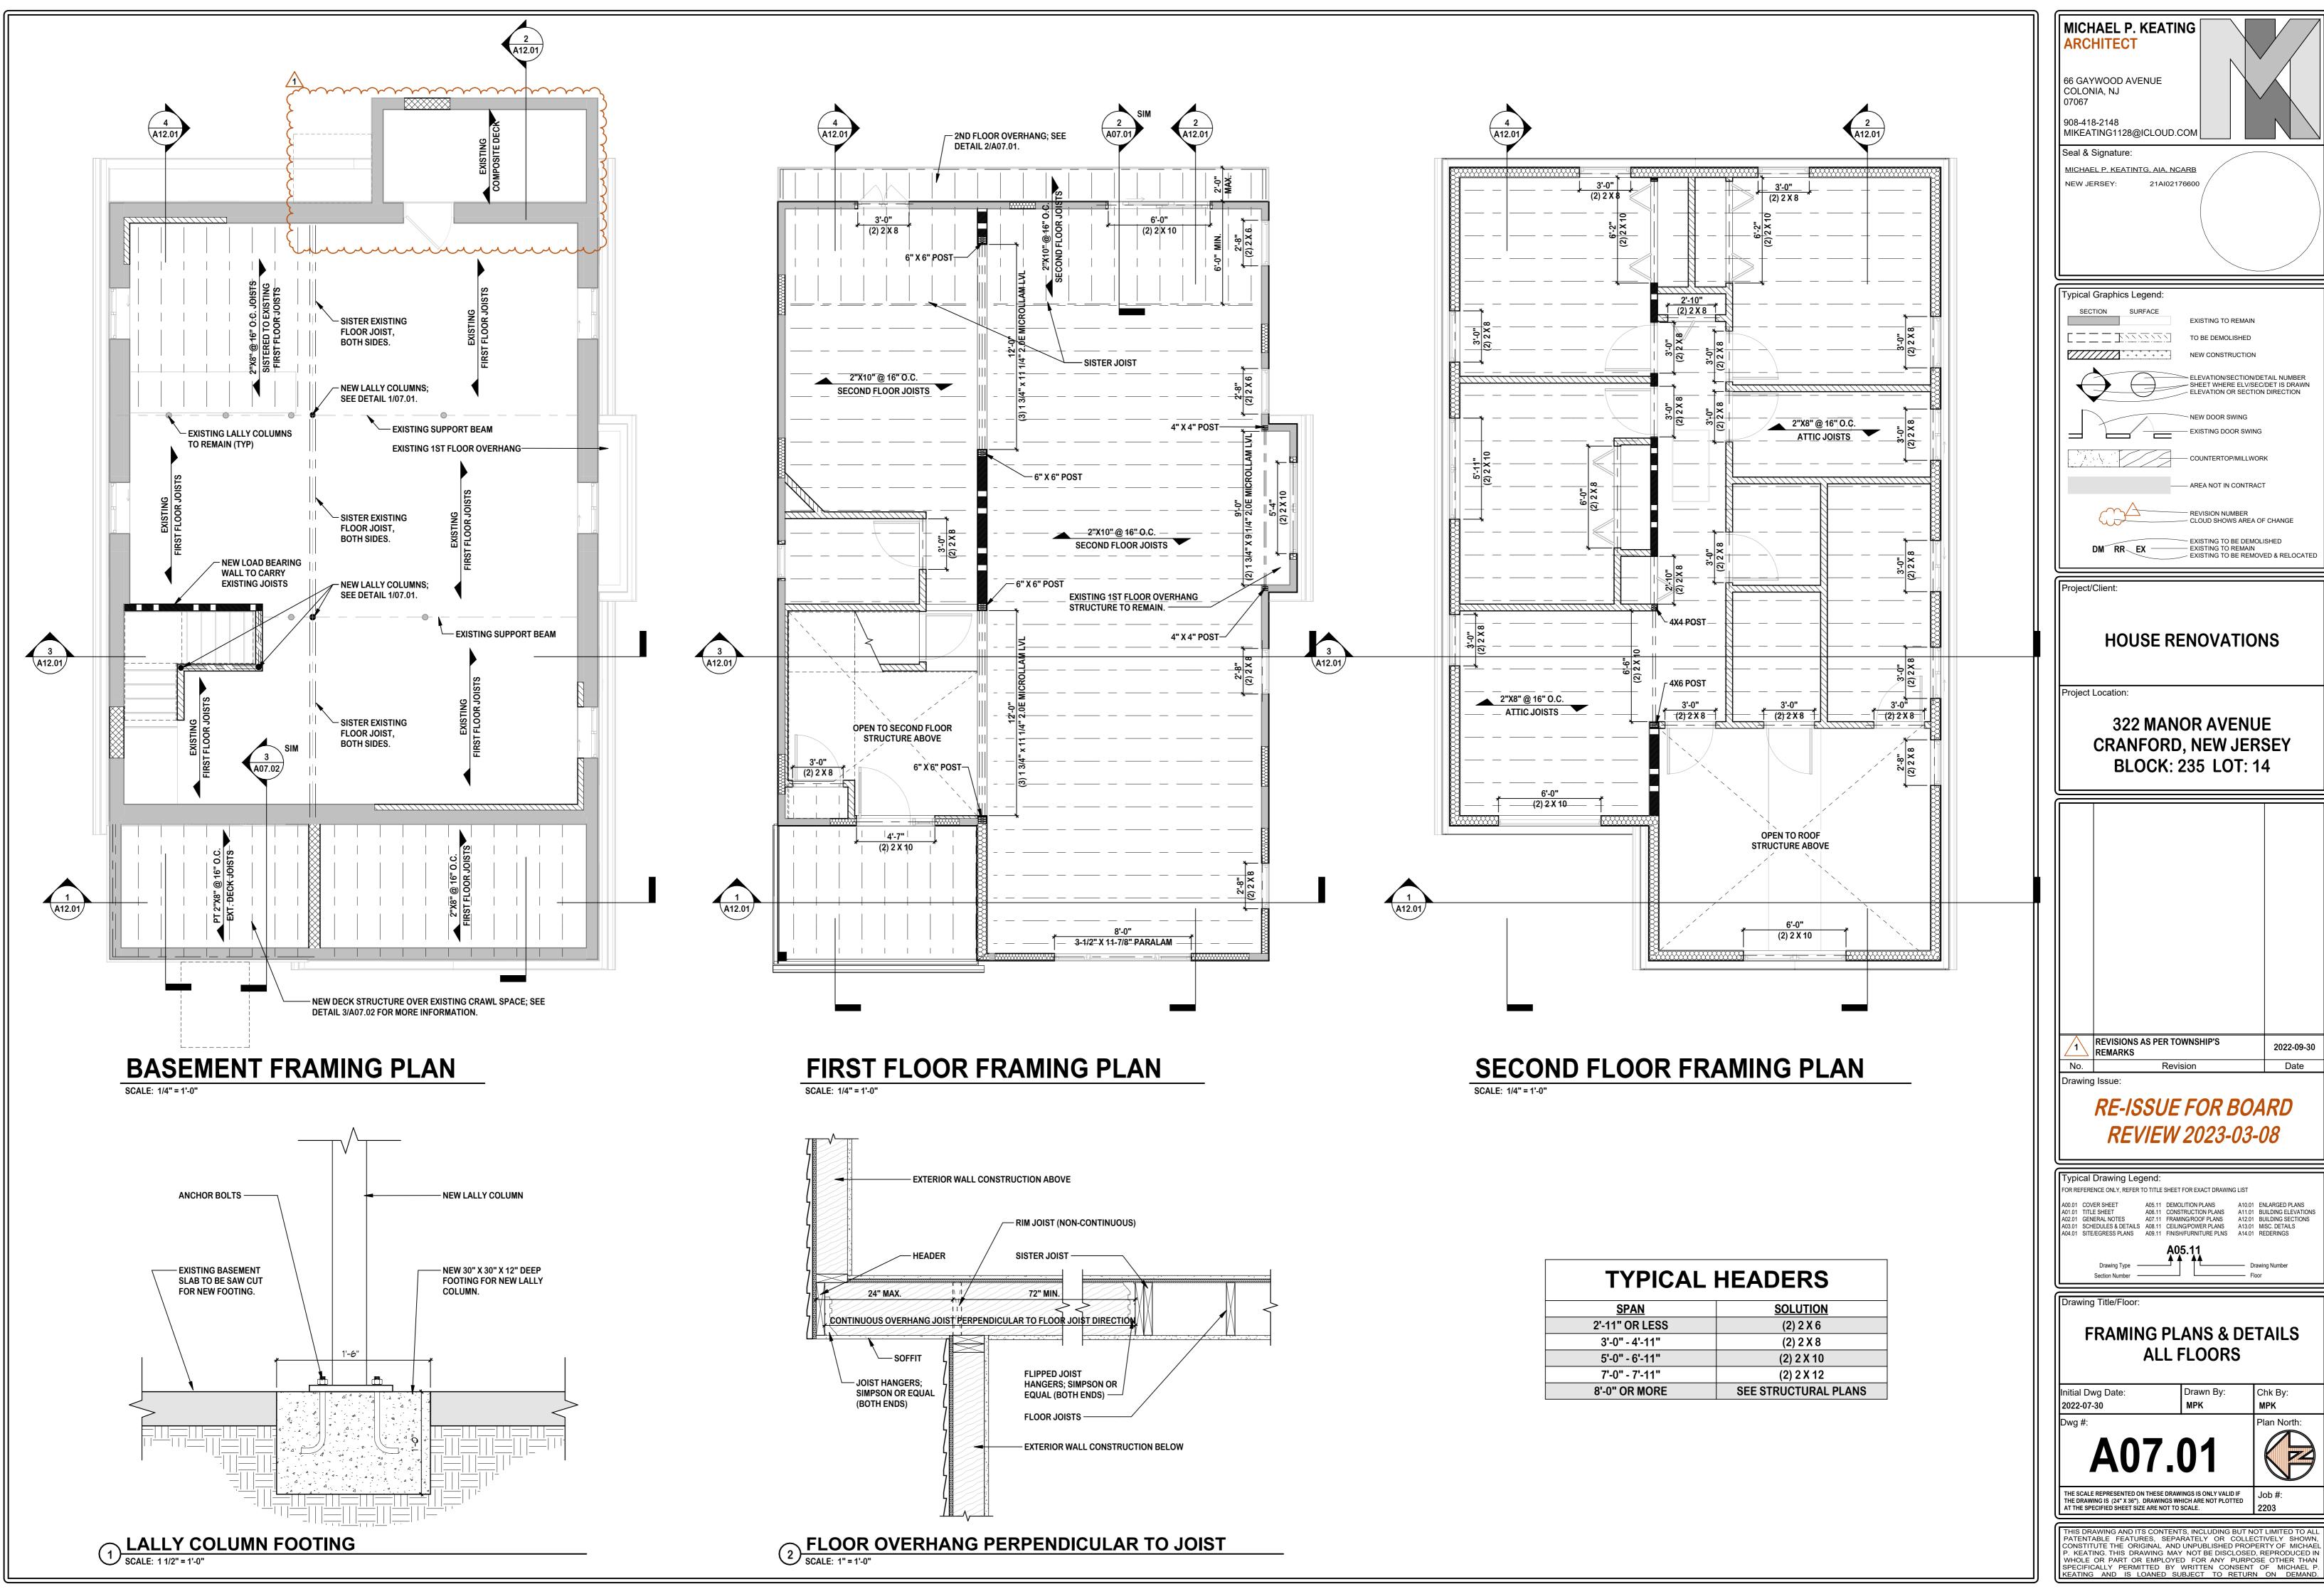
X DOOR TYPES LEGEND:


- A 3'-0" W X 6'-8" H SINGLE HINGE ENTRY DOOR - APPLICATION: EXTERIOR - FIRE RATING: NONE - STYLE: 3 PANEL W/ 1/4 GLASS INLAY - FINISH: TBD - GLAZING: CLEAR
- A1 1'-0" W X 6'-8" H SIDE LITE - APPLICATION: EXTERIOR - FIRE RATING: NONE - STYLE: 1 PANEL W/ FULL GLASS INLAY - FINISH: TBD - GLAZING: CLEAR
- B 5'-8" W X 6'-8" H TWO LEAF SLIDING DOOR - APPLICATION: EXTERIOR - FIRE RATING: NONE - STYLE: 1 PANEL, FULL GLASS - FINISH: TBD
- GLAZING: CLEAR C 2'-8" W X 6'-8" H SGL HINGE DOOR - APPLICATION: INTERIOR - FIRE RATING: NONE - STYLE: 6 PANEL

- FINISH: TBD


- D 5'-8" W X 6'-8" H FOUR LEAF FOLDING DOOR - APPLICATION: INTERIOR - FIRE RATING: NONE
- STYLE: 3 PANEL, HORIZONTAL - FINISH: TBD
- E 2'-6" W X 6'-8" H TWO LEAF FOLDING DOOR - APPLICATION: INTERIOR - FIRE RATING: NONE - STYLE: 3 PANEL, HORIZONTAL - FINISH: TBD
- F 2'-2" W X 4'-6" H ATTIC ACCESS STAIRS
- **DOOR HARDWARE LEGEND:**
- 1 EXTERIOR GRADE LATCH: - TYPE: BUILDING ENTRY - LOCKSET: LOCKABEL WITH DEADBOLT - FINISH: TBD
- 2 EXTERIOR GRADE SLIDING DOOR LATCH: - TYPE: BUILDING ENTRY - LOCKSET: LOCKABEL WITH DEADBOLT - FINISH: TBD
- 3 INTERIOR GRADE KNOB: - TYPE: HALL/CLOSET - LOCK: NONE - FINISH: TBD
- 4 INTERIOR GRADE KNOB: - TYPE: BEDRROM/BATHROOM - LOCK: LOCKABLE - FINISH: TBD
- 5 TYPICAL BI-FOLD DOOR HARDWARE: - TYPE: STANDARD - LOCK: NONE - FINISH: TBD




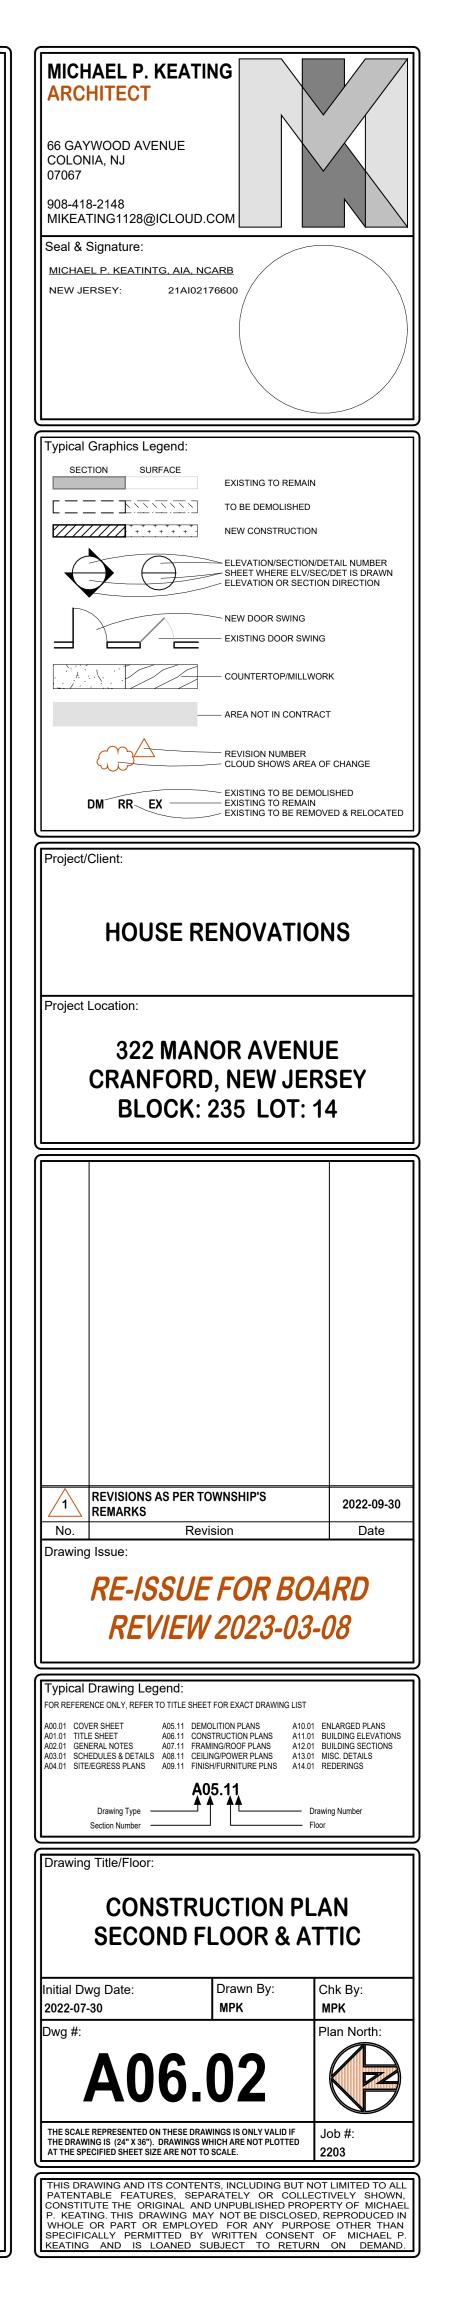


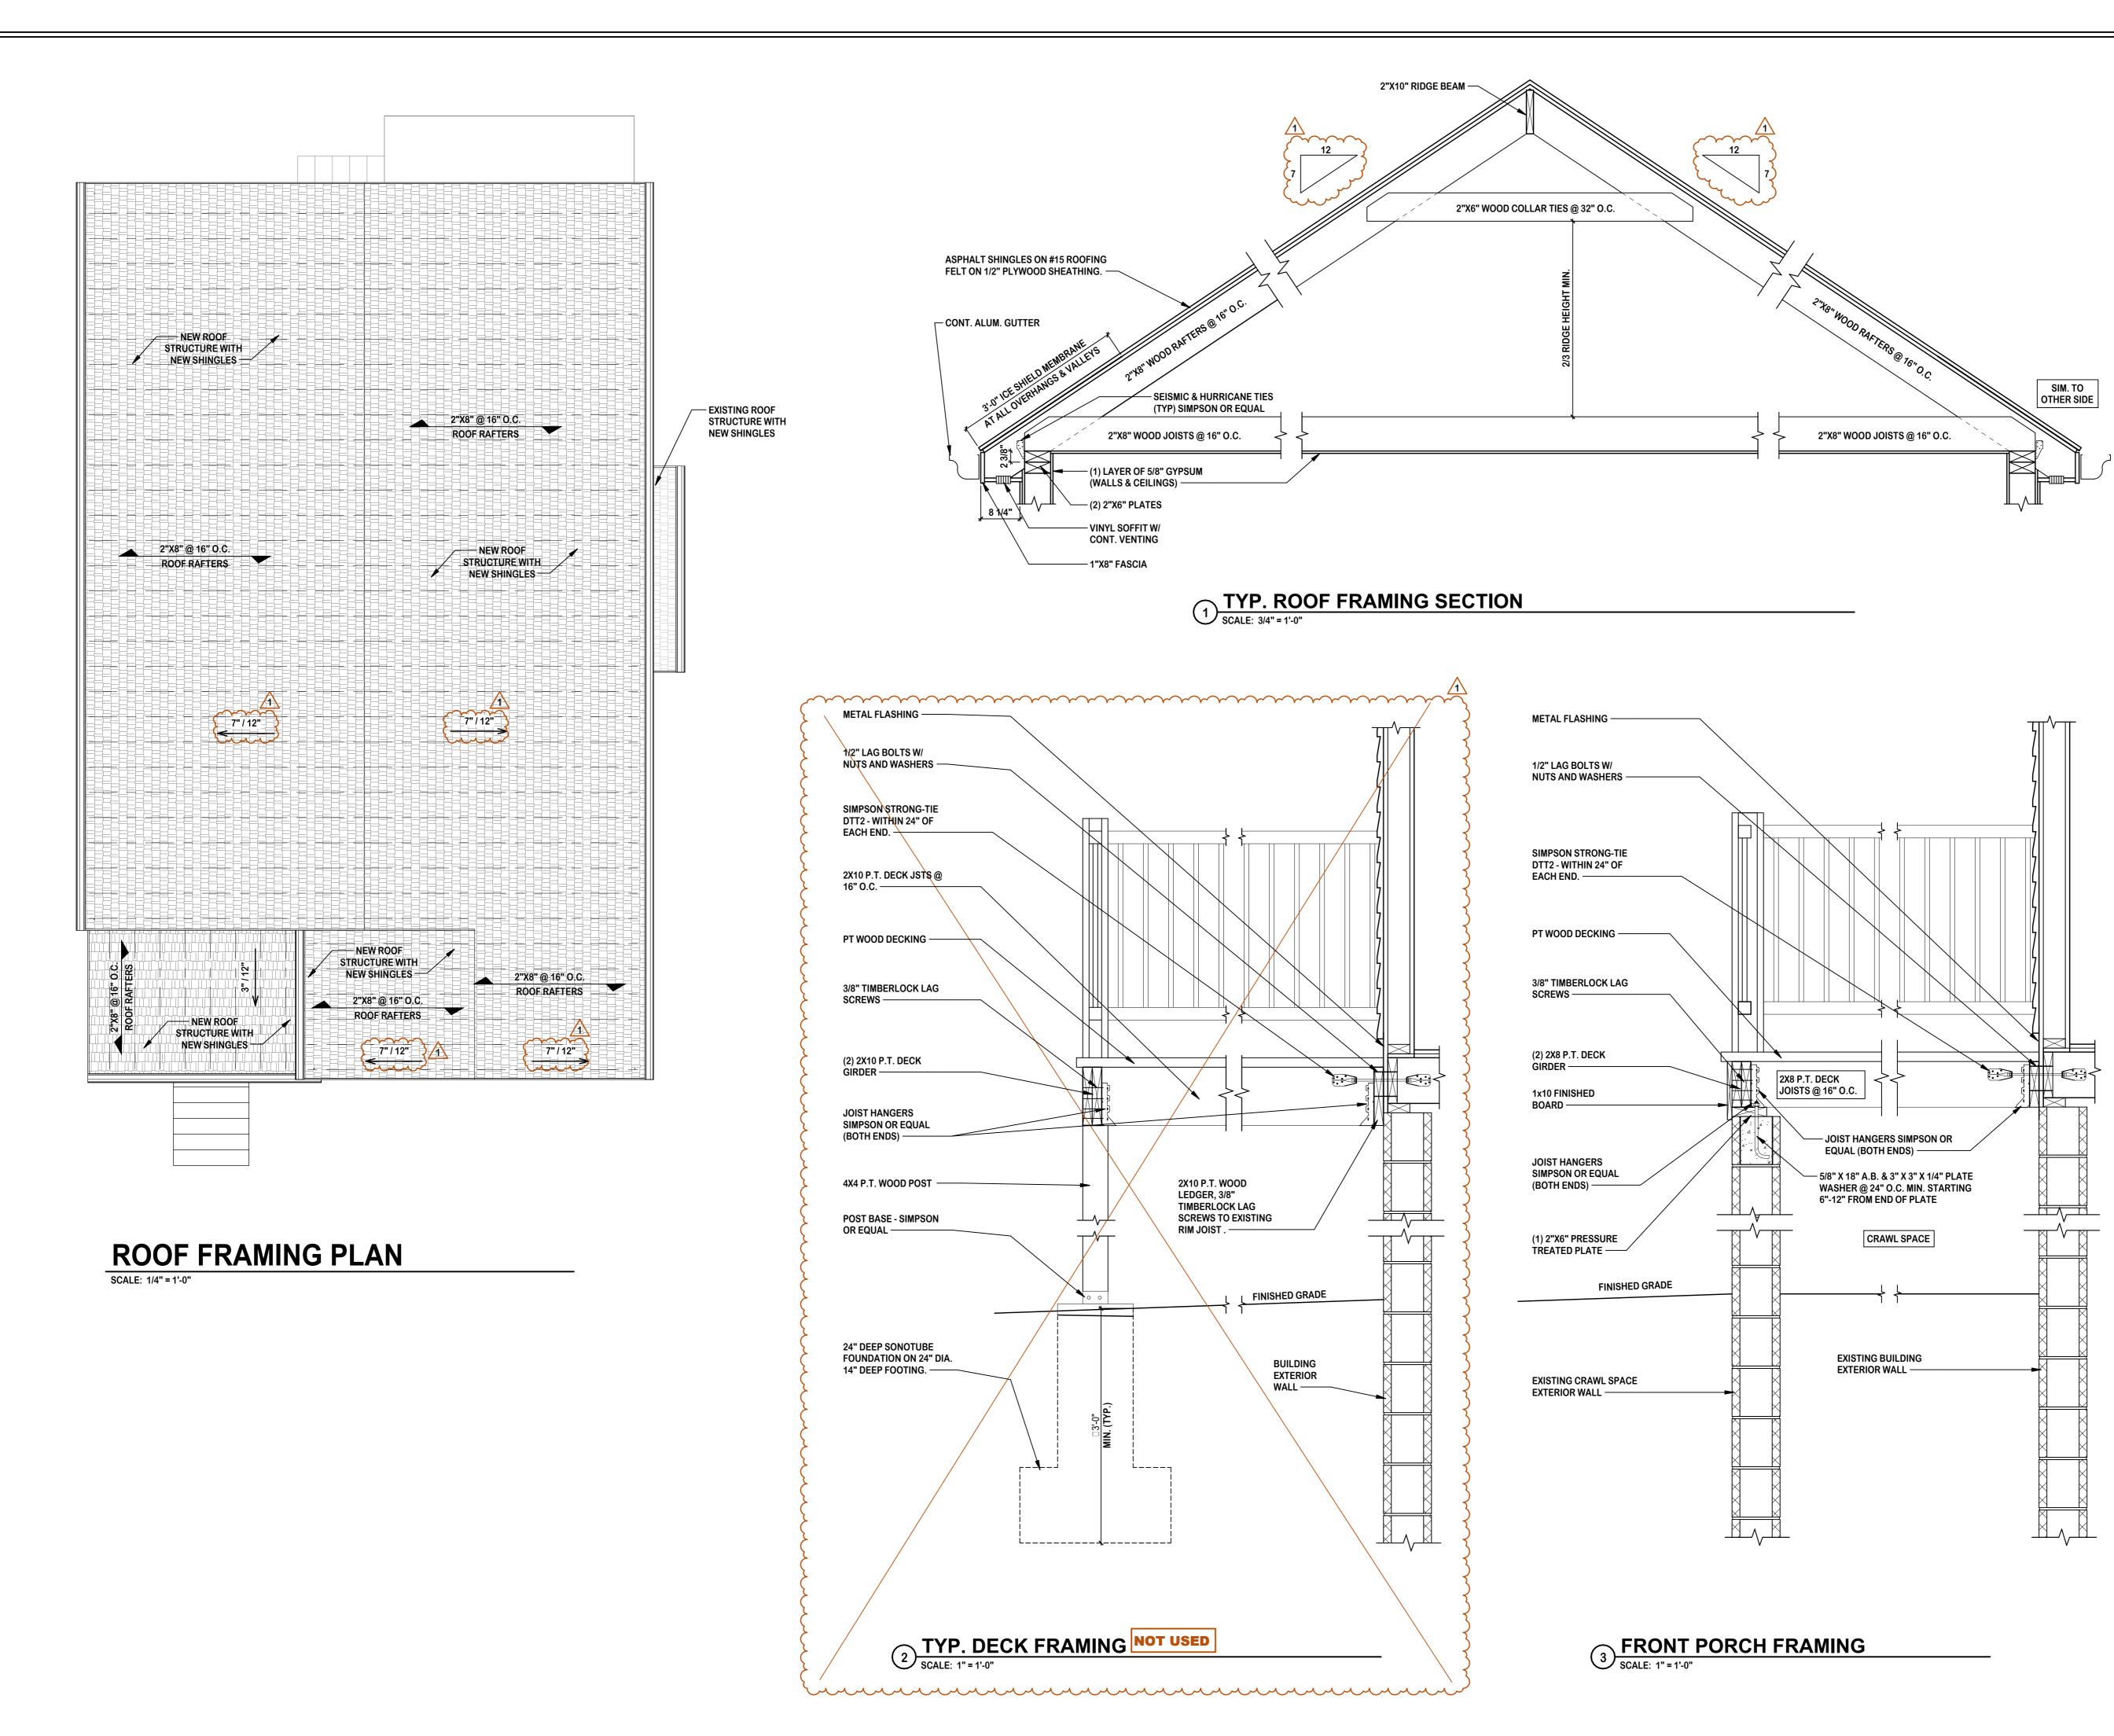

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MIKEATING1128@ICLOUD.C Seal & Signature:	,01		
MICHAEL P. KEATINTG, AIA, NC NEW JERSEY: 21AI0217			
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Typical Graphics Legend: SECTION SURFACE	EXISTING TO R	EMAIN	
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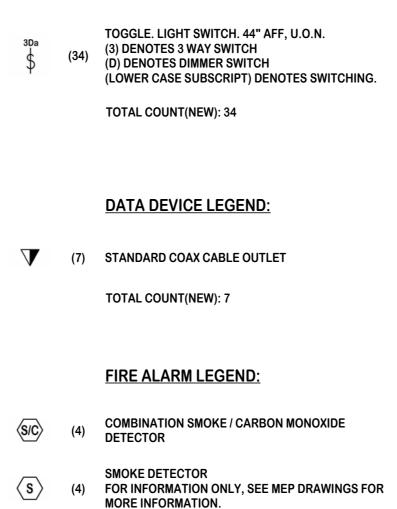


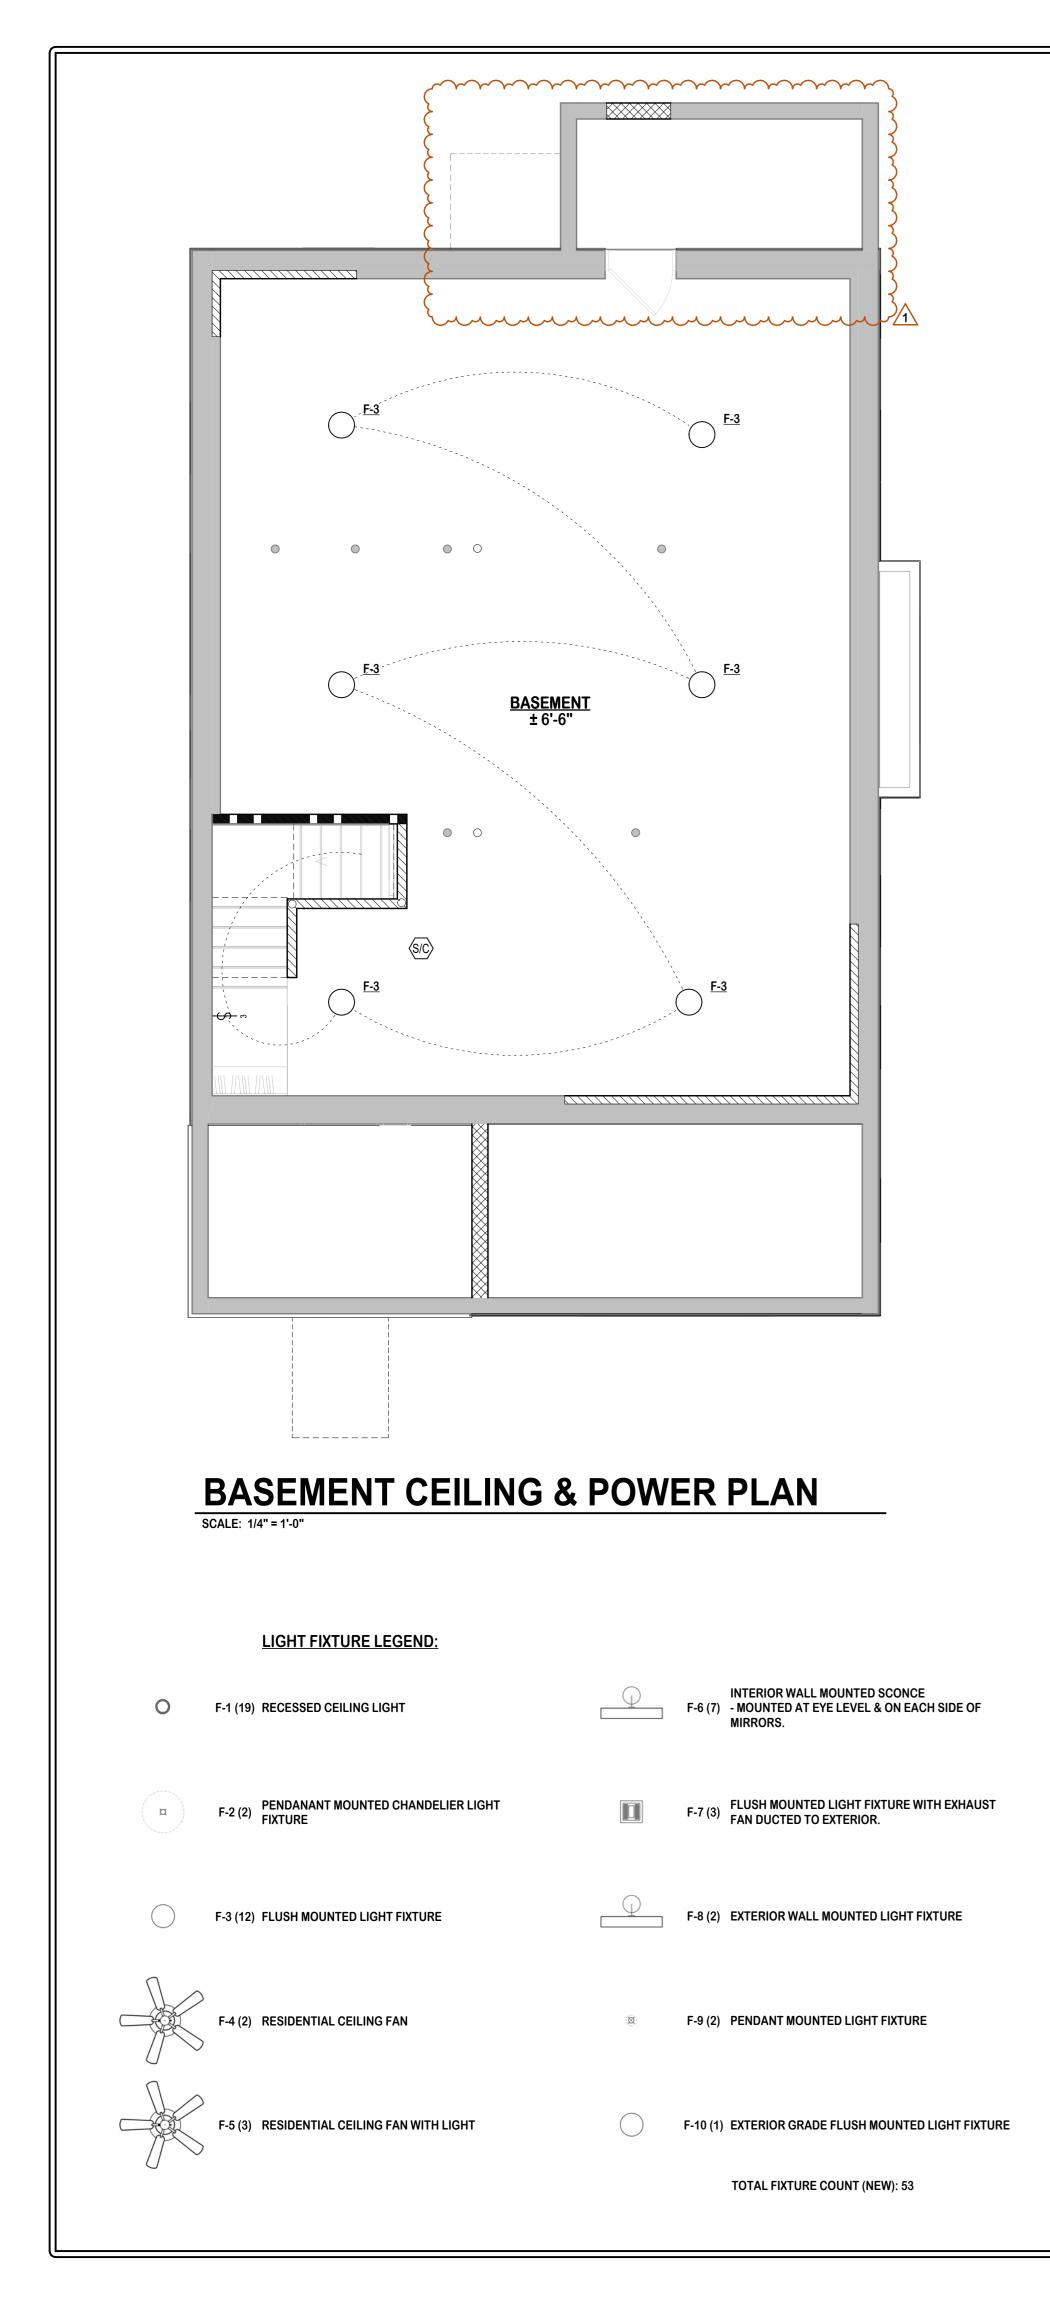

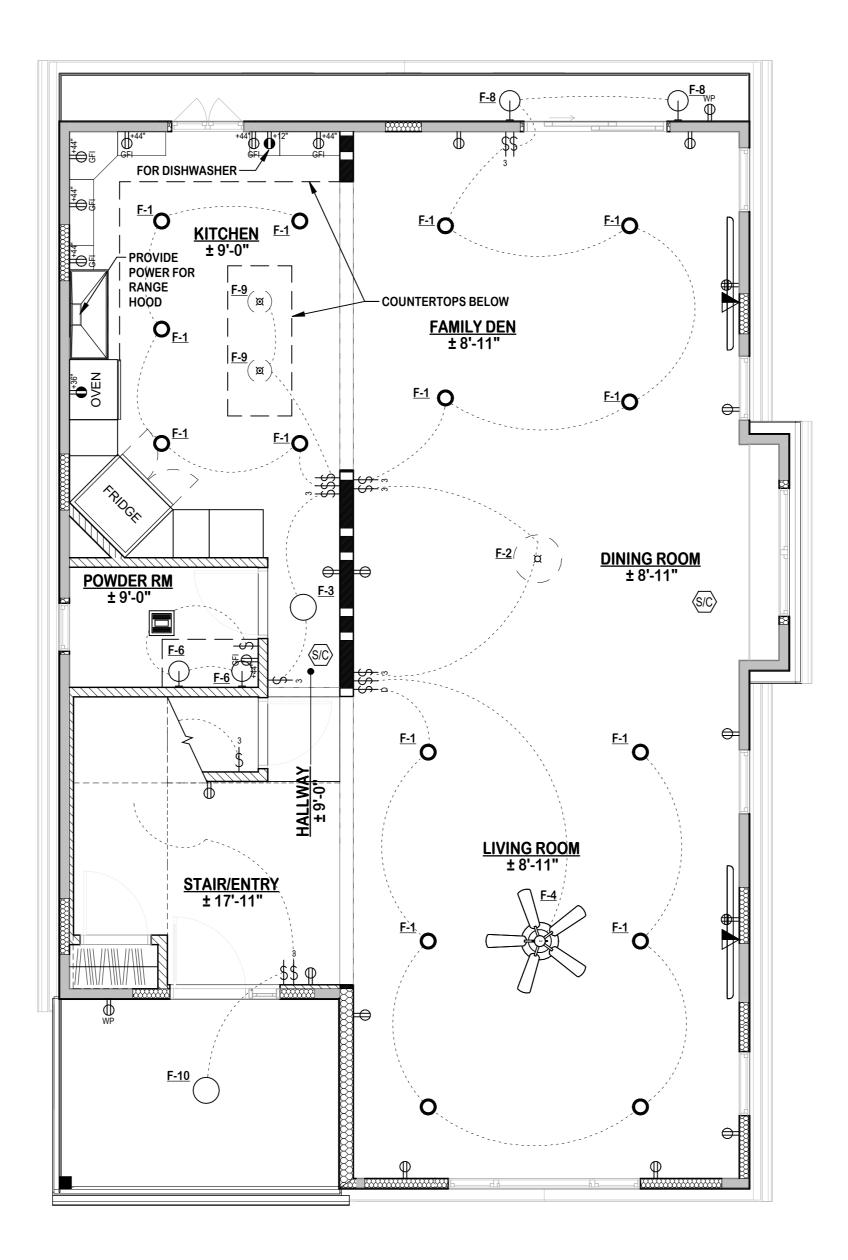FIRST FLOOR CEILING & POWER PLAN

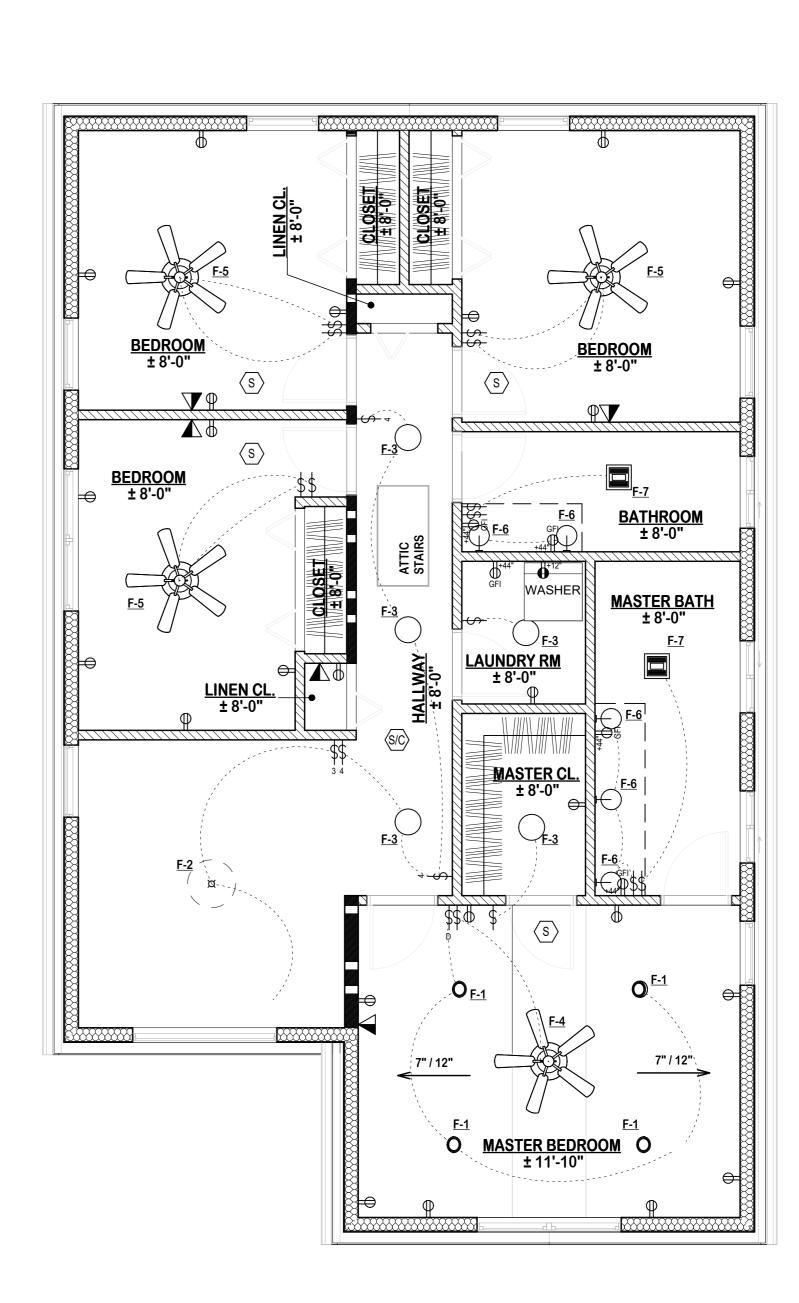SECOND FLOOR CEILING & POWER PLAN

LIGHTING CONTROL LEGEND:



TOTAL COUNT(NEW): 8

STANDARD DOUBLE DUPLEX OUTLET.

ELECTRICAL LEGEND:

(2)

П	(2)	
${\boldsymbol{\varphi}}^{{}_{\!$	(2)	STANDARD DUPLEX OUTLET, WATERPROOF, ON GFCI CIRCUIT.
φ	(36)	STANDARD DUPLEX OUTLET.
Ŷ	(3)	STANDARD SEPARATE CIRCUIT DUPLEX OUTLET.
₽ ^{GFI}	(12)	GROUND FAULT INTERRUPTED DUPLEX ELECTRICAL OUTLET.
		TOTAL COUNT(NEW): 55

ELECTRICAL NOTES:
IN NO CASE SHALL OL

- . IN NO CASE SHALL OUTLETS BE GREATER THAN 6' FROM ANY DOOR OPENING AND NO GREATER THAN 12' (4' IN KITCHEN) BETWEEN EACH OTHER.
- 2. ALL ELEC, TELL. & DATA DEVICES SHOWN WITH AN 'EX' ARE EXISTING TO REMAIN.
- 3. ALL SMOKE AND CO ALARMS TO BE HARDWIRED AND INTERCONNECTED AS PER NJAC <u>5:23-6.32(F)2</u>.
- 4. ALL SMOKE AND CO ALARMS NEAR COOKING APPLIANCES TO BE INSTALLED PER <u>IRC 2018, NJ EDITION R314.3.1</u>.

EL	ECTRICAL/MEC	CHANICAL EQ	UIPMENT
EQUIPMENT	PROPOSED	INSTALLED	REMARKS
AIR COND.	CENTRAIL AIR	NONE	NEW
FIXTURES	54		ALL NEW
HEATING	CENTRAL AIR	HOIT WATER	NEW
RANGE	GAS	GAS	NEW
RECEPTICALS	45		ALL NEW
SERVICE	200 AMP		UPGRADE EXISTING
SERVICE PANEL	200 AMP		UPGRADE EXISTING
SWITCHES	19		ALL NEW
WATER HEATER			EXISTING TO REMAIN

